# VAMC Providence RI 02908 Elevator Upgrades and Modernization Project #650-10-106

# Building 1

Owner
VA Medical Center
830 Chalkstone Ave.
Providence, RI 02908





ISSUE FOR CONSTRUCTION FULLY SPRINKLERED


		mington Ave	Roud St.		Se control of				FULLY SF	PRINKLERED
	CONSULTANTS:			11		ARCHITECT:	Drawing Title COVER SHEET	Project Title Elevator Upgrades and Modernization	Project Number 650-10-106	Office of
	Structural Engineer:	MEP/FP Engineers:	Environmental Engineers	Vertical Transportation	n Specialist	H73			Building Number  1	Construction and Facilities
	Lim Consultants, Inc. 90 Hamilton Street	Thompson Consultants, Inc. 525 Mill Street	CDW Consultants, Inc. 40 Speen Street Suite 301	VDA (Van Deusen & Associates) Independence Wharf	ertical ransportation ystems		Approved: Project Director	Location VAMC PROVIDENCE, RI 02980	Drawing Number	Management
	Cambridge, MA 02139	Marion, MA 02738  THOMPSON CONSULTANTS, INC.	Framingham, MA 01701	470 Atlantic Avenue, 4th Floor Boston, MA 02210	X O Pall	HDR Architecture, Inc.  695 Atlantic Ave   Boston, MA 02111   617.357.7700		Date Checked Drawn	GI001  Dwg. 001 of 030	Department of Veterans Affairs
Revisions: Date								00/20/12	Dwg. OUT OF USU	Veterans Anans

5 6 7

VA FORM 08-6231

#### ABBREVIATIONS ANCHOR BOLT, AUGER BORING FROST PROOF HYDRANT PULL SWITCH FRAME POINT, POINT OF TANGENT AIR BREAK SWITCH AIR CONDITIONING, ASBESTOS CEMENT, ACRES FULL SIZE PARTITION FOOTING PTVC POINT OF VERTICAL CURVE ASPHALTIC CONCRETE FTG AIR CIRCUIT BREAKER FELT JOINT PVC POLY VINYL CHLORIDE ALUMINUM CONDUCTOR STEEL REINFORCED FW FIRE WATER PVI POINT OF VERTICAL INTERSECTION FXTR FIXTURE PVT POINT OF VERTICAL TANGENT ACST ACOUSTIC PVMT PAVEMENT AREA DRAIN, ACCESS DOOR GROUND, GAS LINE, GRAM **ADJUSTABLE** ABOVE FINISHED FLOOR GAGE QT QUARRY TILE AIR HANDLING UNIT GALVANIZED GLAZED COATING RADIUS, RISER, RUBBER SHEATH ALTERNATE GROUND FAULT INTERRUPT RETURN AIR **ALUMINUM** ACOUSTIC MATERIAL GROUND FACE MASONRY UNIT RADIUS RESILIENT VINYL BASE ACCESS PANEL GRADE REFLECTED CEILING PLAN APPROX APPROXIMATE GRD GROUND ROOF DRAIN, ROAD ARCHITECTURAL ARCH GLAZED STRUCTURAL UNIT RECP RECEPTACLE ARR ARRESTOR GROUND WATER RED REDUCING ASPH ASPHALT GYPSUM WALL BOARD REINF REINFORCEMENT AUTOMATIC TRANSFER SWITCH REGULATOR, REGISTER ATS GYPSUM REQD REQUIRED HGT,H HEIGHT, HUMIDIFIER REV REVISION HOSE BIBB RF ROOF, RETURN FAN HANDICAPPED RHC REHEAT COIL BRICK EXPANSION JOINT HARD DRAWN RI RUBBER INSULATED HARDWARE RGS RIGID GALVANIZED STEEL HORN GAP SWITCH HGSW RL RAIN LEADER BEAM HIGH INTENSITY DISCHARGE ROOM BOTTON HORIZ HORIZONTAL REVOLUTIONS PER MINUTE BEARING HIGH POINT RESILIENT VINYL TILE BOTTOM REGISTER HIGH PRESSURE SODIUM HPS HOUR SECOND, SOUTH, SANITARY, SEWER, STRUCTURE HIGH STRENGTH CELSIUS SANITARY SEWER HOT WATER, HEADWALL CAPACITY SUSPENDED ACOUSTICAL TILE CEILING HIGH WATER LEVEL CIRCUT BREAKER SCH SCHEDULE CENTER TO CENTER SPLITTER DAMPER, STORM DRAIN HERTZ CEILING DIFFUSER SOUTHEAST CEM CEMENT SECT SECTION INSIDE DIAMETER, CFMF COLD FORMED METAL FRAMING INSIDE DIMENSION SERV SERVICE CORNER GUARD SILT FENCE INVERT ELEVATION C&G CURB AND GUTTER SUPPLY GRILLE INTERMEDIATE METAL CONDUIT CHILLER SHEET INTERIOR CAST IRON, COURTYARD INLET SIMILAR INSULATION, INSULATED CIP CAST IRON PIPE 1 PH SINGLE PHASE INVFRT CIR CIRCULATING SUSPENDED KEENE'S CEMENT PLASTER INTERSECTION CONTROL JOINT SLOPE INLET PROTECTION CKT **CIRCUIT** INDUSTRIAL RESIN BASE FLOORING SMH SANITARY MODULE GREATER THAN STATIC PRESSURE, SINGLE POLE **CEILING** SPC SUSPENDED PLASTER CEILING JUNCTION BOX CLEAR SPDT SINGLE POLE, DOUBLE THROW JANITOR CLOSET CMP CORRUGATED METAL PIPE JUNCTION SPEC SPECIFICATION CMPA CORRUGATED METAL PIPE ARCH SPST SINGLE POLE, SINGLE THROW JOINT CONCRETE MASONRY UNITS JOIST SQUARE CND,C CONDUIT SUPPLY REGISTER CNDS CONDENSATE SANITARY SEWER CLEANOUT STEAM, SINGLE THROW, STREET THOUSAND AMP INTERRUPT CAPACITY CODP CLEANOUT W/ DECK PLUG KEENE'S CEMENT PLASTER STA STATION COL COLUMN STD STANDARD KILOGRAM COMMUNICATION CONCRETE KNOCK OUT CONDUCTOR COND SUSP SUSPENDED KILOVOLT CONNECTION SHEET VINYL KILOVOLT-AMPERE CONST CONSTRUCTION SWITCH, SIDEWALK KILOWATT CONT CONTINUOUS SWITCHBOARD CONV CONVERTER SWGR SWITCHGEAR LITERS PER SECOND COP,CU LOUVER, LENGTH, LENGTH OF CURVE NONREINFORCED CONCRETE PIPE TILE, TOP, TANGENT LIGHTNING ARRESTOR CARD READER TOP AND BOTTOM LEAD COVERED CRS STAINLESS STEEL TC TOP OF CURB LIVE LOAD CONCRETE SEALER/SURFACE TELEPHONE LONG LEG HORIZONTAL TEMP TEMPERATURE, TEMPORARY LONG LEG VERTICAL CERAMIC TILE. CURRENT TRANSFORMER. TERM TERMINAL LIGHT COOLING TOWER THREE CONDUCTOR LAVATORY VERTICAL CENTER, COOLING TOWER RETURN 3/P THREE POLE LENGTH OF VERTICAL CURVE COOLING TOWER SUPPLY 3 WAY THREE WAY TOTAL HEAD (PUMPS) M/S METERS PER SECOND CAPILLARY WATER BARRIER THRSLD THRESHOLD METER, MEGA CONTR CONTRACTION TOP OF TEST PIT MAS MASONRY TOP REGISTER MATERIAL DEPTH, DEEP, DEGREE OF CURVATURE TRANSITION MAXIMUM DRY BULB, DECIBEL, DIRECT BURIAL TOP OF STEEL, TOP OF STONE, TOP OF SLAB MECHANICAL DIVERSION DIKE TELEVISION METAL DETAIL TW TOP OF WALL MANHOLE DRILL HOLE TYPICAL MINIMUM, MINUTE DUCTAL IRON MISCELLANEOUS DIAMFTER UNDERGROUNI MAIN LUG ONLY DIMENSION UNDER COUNTER REFRIGERATOR MILLIMETER DEAD LOAD UNDERGROUND ELECTRIC MOTOR OPERATED, MASONRY OPENING, Damper UNDERGROUND TELEPHONE MIDDLE ORDINATE DOWN UH UNIT HEATER MEDIUM PRESSURE UFAS UNIFORM FEDERAL ACCESSIBILITY STANDARDS MOUNTED DISTRIBUTION PANEL MOUNTING DOWNSPOUT, STORM DRAINAGE STRUCTURE VENT, VOLT, VALVE MEMBRANE WATERPROOFING VOLT AMPRE DOMESTIC WATER MULL MULLION VACUUM VCT VINYL COMPOSITION TILE NORTH NOT APPLICABLE V ASB VINYL ASBESTOS VARNISH CAMBRIC, VITRIFIED CLAY NON CORROSIVE VITRIFIED CLAY PIPE NORTHEAST EXCEPT AS NOTED VENT VENTILATING NOSE DOWN CURB ENTERING AIR TEMPERATURE VERT VERTICAL NATIONAL ELECTRIC CODE EMPTY CONDUIT VEST VESTIBULE NEUT NEUTRAL EACH FACE, EXHAUST FAN VPI VERTICAL POINT OF INTERSECTION NOT IN CONTRACT EXHAUST GRILLE VPOC VERTICAL POINT OF CURVE EXPANSION JOINT VPOT VERTICAL POINT OF TANGENT NOMINAL ELEVATION VS VENT STACK NOMINAL PIPE SIZE ELECTRIC VTR VENT THRU ROOF NOT TO SCALE ELEVATOR VWC VINYL WALL COVERING NORTHWEST ELECTRICAL METALLIC TUBING **EMERGENCY** OUTSIDE AIR WIDTH, WASTE, WATER, WATT, WEST, WIRE, EDGE OF PAVEMENT ON CENTER OIL CIRCUIT BREAKER WITH OUTSIDE DIAMETER EQUIPMENT WITHOUT OP.HD. OPPOSITE HAND EXHAUST REGISTER WET BULB OPNG OPENING **FVAPORATIVE** WATER CLOSET OPPOSITE EACH WAY WIDTH, WINDOW DIMENSION OSD OPEN SITE DRAIN WALK OFF MATT OVHD,OH OVERHEAD WATER LEVEL EXISTING WATERPROOF, WEATHERPROOF EXP EXPANSION, EXPOSED WASTE STACK, WATER SURFACE, WATERSTOP PIPE, POLE EXTERIOR PULL BOX WWF WELDED WIRE FABRIC POINT OF INTERSECTION POST INDICATOR VALVE FIRE ALARM XFMR TRANSFORMER PREFORMED JOINT FILLER FABX FIRE ALARM BOX PLATE X-STR UNIT HEATER FLOOR DRAIN, FIRE DAMPER PLAS PLASTER FDN FOUNDATION 2:1 SL 2 HORIZONTAL TO 1 VERTICAL SLOPE PLNJ PAPER AND LEAD NEOPRENE JACKET 1 ON 2 1 VERTICAL ON 2 HORIZONTAL SLOPE FIRE EXTENGUISHER PNL PANEL FINISHED FLOOR ELEVATION DEFLECTION ANGLE PAINT FIRE HYDRANT PRELIM PRELIMINARY FIRE HOSE CABINET PRESS PRESSURE DIAMETER, PHASE PRIM PRIMARY FINISH PRESSURE RELIEF VALVE FLOOR, FLASHING, FLOW LINE CONSULTANTS: Structural Engineer: Lim Consultants, Inc.

VA FORM 08-623

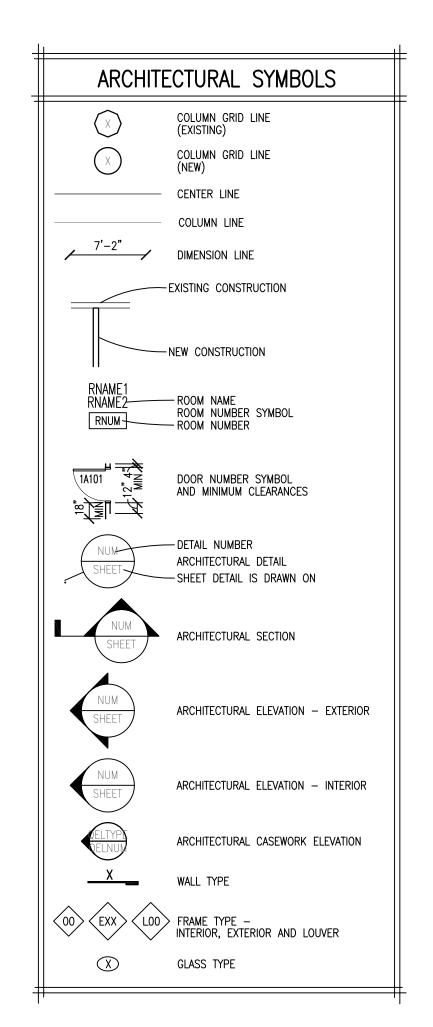

## MATERIAL SYMBOLS

COARSE POROUS FILL

CAST-IN-PLACE CONCRETE

CONTINUOUS WOOD FRAMING

WOOD BLOCKING

FINISH LUMBER FOR ARCHITECTURAL WOODWORK

FIBROUS INSULATION

GLASS (LARGE SCALE) LATH AND PLASTER

GYPSUM BOARD

RESILIENT TILE (LARGE SCALE)

### GENERAL NOTES

- 1. THE CONTRACTOR IS TO COMPLY WITH THE LATEST AND MOST CURRENT EDITIONS OF VA APPLICABLE NATIONAL, STATE AND LOCAL BUILDING CODES AND REGULATIONS AS WELL AS LOCAL. STATE AND FEDERAL REGULATIONS REGARDING HEALTH AND SAFETY IN THE WORKPLACE.
- THE CONTRACTOR IS RESPONSIBLE FOR OBTAINING AND POSTING ALL REQUIRED VALID CONSTRUCTION/DEMOLITION PERMITS PRIOR TO THE START OF ON SITE CONSTRUCTION. THE CONTRACTOR SHALL BE RESPONSIBLE FOR ALL ASSOCIATED PERMIT FEES, LICENSES AND INSPECTIONS NECESSARY FOR THE PROPER EXECUTION OF THE WORK
- ALL EXISTING CONDITIONS AND DIMENSIONS SHALL BE VERIFIED BY THE CONTRACTOR PRIOR TO FABRICATION AND CONSTRUCTION. ANY DISCREPANCIES BETWEEN EXISTING CONDITIONS AND THESE DRAWINGS, WHICH AFFECT THE SCOPE AND THE INTENT OF THE CONTRACT DOCUMENTS SHALL BE BROUGHT TO THE ATTENTION OF THE ARCHITECT IN WRITING IMMEDIATELY.
- 4. THE CONTRACTOR IS SOLELY RESPONSIBLE FOR ALL CONSTRUCTION ACTIVITIES, MEANS, AND METHODS. THE CONTRACTOR IS TO COORDINATE ALL SEPARATE SUB-CONTRACTORS TO COMPLETE THE FULL SCOPE OF DEMOLITION AND CONSTRUCTION AS INDICATED IN THE CONSTRUCTION DOCUMENTS. THE CONTRACTOR SHALL KEEP ALL BUILDING MEANS OF EGRESS CLEAR OF ANY OBSTRUCTIONS AT ALL TIMES. THE
- CONTRACTOR IS TO ALLOW FOR EMERGENCY EGRESS AT THE SCOPE OF WORK AREA BY ALL PERSONS VIA THE REQUIRED THE CONTRACTOR SHALL NOT OBSTRUCT TRAFFIC OUTSIDE OF THE OR BUILDING ANY ADJACENT RIGHT OF WAY DURING
- DEMOLITION OR CONSTRUCTION. EXPECT AS APPROVED BY VA FACILITES DIRECTOR. THE CONTRACTOR SHALL PROVIDE OSHA APPROVED SAFETY BARRIERS SURROUNDING ALL NEW FLOOR PENETRATIONS AND
- BUILDING PERIMETERS AS WELL AS EXISTING PENETRATIONS AND OPENINGS TO BE ALTERED. ACCESS TO THE WORK AREA IS TO BE RESTRICTED BY THE CONTRACTOR. ENTRANCES ARE NOT TO BE LEFT UNATTENDED AT ANY TIME. DOORS ARE NOT TO BE LEFT OPEN. THE CONTRACTOR IS RESPONSIBLE FOR SECURING THE AREA AND EQUIPMENT WITHIN THE SCOPE OF WORK AS WELL AS THE COMMON AREAS AND SITE OF THE FACILITY AS
- REQUIRED. THE CONTRACTOR IS TO MINIMIZE THE DISRUPTION OF THE COMMON AREAS OF THE BUILDING DURING DEMOLITION AND CONSTRUCTION. DELIVERIES OF MATERIALS AND REMOVAL OF DEBRIS ARE TO BE COORDINATED WITH THE VA FACILITIES DIRECTOR AND SCHEDULED SO AS NOT TO CAUSE INCONVENIENCE TO OTHER BUSINESSES, FACILITIES, AND MAY REQUIRE OFF HOURS DELIVERY OR REMOVAL OF MATERIALS BY THE CONTRACTOR.
- NO RELOCATION WORK OF HOSPITAL SYSTEMS IS TO BE LEFT INCOMPLETE UPON THE END OF EACH AVAILABLE WORK PERIOD CAUSING EXISTING HOSPITAL SERVICE INTERRUPTIONS. THE CONTRACTOR IS TO COORDINATE THE SCHEDULING OF ALL REQUIRED RELOCATIONS AND SHUT-DOWNS OF HOSPITAL SERVICES AND SYSTEMS WITH THE HOSPITAL IN ADVANCE
- TO ASSURE NO INTERRUPTIONS OF HOSPITAL OPERATIONS OR SERVICES. 11. EXISTING BUILDING ELEVATORS, STAIRS AND BUILDING SPACES ARE TO BE PROTECTED DURING DEMOLITION AND CONSTRUCTION AS REQUIRED. ANY BUILDING SPACE DAMAGED DURING CONSTRUCTION IS TO BE REPAIRED AND/OR REPLACED TO MATCH THE ORIGINAL EXISTING CONDITION AT THE CONTRACTOR'S EXPENSE. ALL FLOOR SURFACES ARE TO BE KEPT BROOM CLEAN. CARPETS SOILED BY THE CONTRACTOR ARE TO BE CLEANED TO HOSPITAL'S APPROVAL AT
- 12. THE TERM "FINISH FLOOR" SHALL MEAN THE NORMAL FINISHED SURFACE OF THE FLOOR LEVEL. ALL ELEVATIONS GIVEN FOR EXISTING BUILDINGS ARE TO FINISHED FLOOR. THE CONTRACTOR SHALL FIELD VERIFY ALL ELEVATIONS FOR EXISTING STRUCTURES PRIOR TO THE COMMENCEMENT OF WORK.
- 13. ALL ELECTRICAL, MECHANICAL, HVAC, PLUMBING/FIRE PROTECTION INDICATIONS ON ARCHITECTURAL DRAWINGS ARE FOR
- LOCATION PURPOSES ONLY. SEE MEP/FP DRAWINGS FOR INFORMATION REGARDING THESE DISCIPLINES 14. ALL FINISHES AND COLORS SHALL BE SELECTED AND/OR REVIEWED BY THE ARCHITECT PRIOR TO ORDERING AND
- INSTALLATION. 15. ALL DIMENSIONS INDICATED AT NEW PARTITIONS ARE TO FACE OF WALL FINISH EXCEPT IN THE CASE OF APPLIED FINISHES SUCH AS CERAMIC TILE.
- 16. PROVIDE FIRE TREATED WOOD BLOCKING AND GAV. SHEET METAL BACKING IN METAL STUD WALLS AS REQUIRED FOR ALL WALL HUNG FIXTURES, CABINETRY, SHELVING, CHAIRAILS, EQUIPMENT HARDWARE AND FINISHES. (SEE INTERIOR ELEVATIONS FOR LOCATIONS OF ALL ITEMS.)
- 17. ALL EXPOSED EXISTING AND NEW FLOOR SLAB PENETRATIONS AND FIRE RATED WALL PENETRATIONS ARE TO BE SEALED WITH FIRE SAFEING INSULATION AND APPROVED SMOKE SEALANT TO MEET REQUIRED FIRE RATING AT PENETRATION.
- 18. ALL PARTITION PENETRATIONS SHOULD BE SEALED WITH INSULATION AND SEALED TIGHT TO PENETRATION.
- 19. THE CONTRACTOR IS TO PROVIDE AND COMPLY WITH ALL REQUIRED HOSPITAL INTERIM LIFE SAFETY MEASURES AS THEY ARE IMPACTED BY THE PROJECT REQUIRED SCOPE OF WORK.

#### DEMOLITION GENERAL NOTES

THE CONTRACTOR'S EXPENSE.


- 1. THE EXTENT OF THE DEMOLITION WORK INDICATED IN DRAWINGS, NOTES, AND SPECIFICATIONS DESCRIBE THE GENERAL SCOPE OF WORK ONLY AND ARE NOT INTENDED TO BE INCLUSIVE OF ALL OF THE DEMOLITION WORK WHICH MAY BE REQUIRED TO COMPLETE THE FULL SCOPE OF WORK.
- THE CONDITION OF ALL BUILDING FINISHES NOT TO BE ALTERED OR REMOVED ARE TO BE REVIEWED AND RECORDED PRIOR TO THE START OF DEMOLITION AND CONSTRUCTION.
- THE HOSPITAL WILL PROVIDE AND PAY FOR ALL WATER, AND ELECTRICAL POWER REQUIRED BY THE CONTRACTOR DURING DEMOLITION AND CONSTRUCTION. THE LOCATIONS OF THESE SERVICES ARE TO BE COORDINATED WITH THE HOSPITAL PRIOR TO DEMOLITION.
- 4. ALL AREAS AFFECTED BY DEMOLITION AND CONSTRUCTION ARE TO BE PROVIDED WITH TEMPORARY LIGHTING, EGRESS SIGNAGE, AND HEATING/EXHAUST/VENTILATION AS REQUIRED.
- ALL DEMOLITION RELATED TEMPORARY OPENINGS IN EXTERIOR WALLS AND ROOF ARE TO BE SECURED AND KEPT WEATHER TIGHT
- ALL DEMOLITION DEBRIS IS TO BE PLACED IN DUMPSTER(S) AND SECURED AS REQUIRED PRIOR TO DISPOSAL. DEBRIS WHICH IS SCATTERED AFTER REMOVAL IS TO BE PROMPTLY REMOVED AND DISPOSED OF PROPERLY. DUMPSTER/CONTAINER LOCATIONS ARE TO BE COORDINATED WITH THE HOSPITAL PRIOR TO DEMOLITION.
- EXISTING MECHANICAL (HVAC), PLUMBING, FIRE PROTECTION, AND ELECTRICAL SERVICES/FIXTURES WHICH ARE TO REMAIN WITHIN THE SCOPE OF DEMOLITION WORK ARE TO BE PROTECTED FROM DAMAGE OR DISRUPTION DURING DEMOLITION AND CONSTRUCTION. (SEE MEP/FP)
- EXISTING MECHANICAL (HVAC), PLUMBING, FIRE PROTECTION AND ELECTRICAL SERVICES THAT PENETRATE A FLOOR ABOVE OR BELOW THAT ARE TO BE REMOVED, ARE TO BE REMOVED COMPLETELY, INCLUDING REMOVAL OF SLEEVES AND OTHER PENETRATION DEVICES. ALL FLOOR PENETRATIONS ARE TO BE PATCHED SMOOTHLY AND FLUSH TO FORM A SOUND STRUCTURAL PATCH. THE ARCHITECT IS TO BE NOTIFIED IN WRITING OF ANY EXISTING PENETRATION GREATER THAN 12" IN ANY DIRECTION WHICH IS TO BE PATCHED
- REMOVE APPLIED FINISHES TO COLUMNS AND STRUCTURAL ELEMENTS AS MAY BE REQUIRED. ALL EXISTING BUILDING FINISHES, INDICATED TO REMAIN, WHICH ARE DISTURBED FOR REQUIRED DEMOLITION ARE TO BE PATCHED AND REPAIRED AS REQUIRED TO MATCH EXISTING CONDITIONS OR AS INDICATED IN THE FINISH
- 11. ALL PARTITIONS INDICATED TO BE REMOVED, ARE TO BE COMPLETELY REMOVED FROM FLOOR DECK TO UNDERSIDE OF STRUCTURE ABOVE.
- 12. THE EXISTING BUILDING STRUCTURE INCLUDING BUT NOT LIMITED TO COLUMNS, BEAMS, AND FLOORS ARE NOT TO BE ALTERED OR DAMAGED DURING DEMOLITION OR CONSTRUCTION, EXCEPT WHERE INDICATED IN THE DRAWINGS. ANY STRUCTURAL ELEMENTS DAMAGED DURING DEMOLITION OR CONSTRUCTION ARE TO BE REPAIRED TO FULL STRUCTURAL INTEGRITY AND REQUIRED FIRE-RESISTIVE RATING BY THE CONTRACTOR AT HIS/HER EXPENSE
- 13. EXISTING EXPOSED AND VISIBLE FIRE PROTECTION MATERIALS AT BUILDING STRUCTURAL COMPONENTS (COLUMNS, BEAMS, FLOOR CONSTRUCTION) ARE TO BE REVIEWED AND DOCUMENTED BY THE CONTRACTOR AS PART OF THE DEMOLITION PORTION OF THE WORK. THE PURPOSE OF THIS DOCUMENTATION IS FOR THE CONTRACTOR TO PROVIDE ANY NECESSARY REPAIR/REPLACEMENT OF FIRE RESISTIVE MATERIAL AT STRUCTURAL COMPONENTS TO MEET CODE REQUIRED FIRE RESISTIVE PROTECTION OF THESE COMPONENTS.

#### LIST OF DRAWINGS


DDAMING NO DDAMING NAME

DRAWING NO.	DRAWING NAME
GENERAL	
GI001	COVER SHEET
GI002	GENERAL INFO & DATA
GI101	LIMIT OF WORK / KEY PLAN / ACCESS PLAN (FIRST FLOOR LEVEL INDICATED)
GI102	PHASING PLAN (FIRST FLOOR LEVEL INDICATED)
ARCHITECTURAL	
AS101	PLANS ELEVATOR NOS. P2, P3 & P4 (BASE BID)
AS102	PLAN/HOISTWAY SECTIONS ELEVATOR NOS. P2, P3 & P4 (BASE BID)
AS103	PLANS/HOISTWAY SECTION DUMBWAITER (BID OPTION NO 1)
AS104	PLANS/HOISTWAY SECTION ELEVATOR NO. S5 (BID OPTION NO 2)
AS105	PLANS/HOISTWAY SECTION ELEVATOR NO. S6 (BID OPTION NO 3)
AS106	PLANS ELEVATOR NO. P7 (BID OPTION NO 4)
AS107	PLANS ELEVATOR NO. P8 (BID OPTION NO 5)
AS108	PLANS/HOISTWAY SECTION ELEVATOR NO. S1 (BID OPTION NO 6)
Al201	ENLARGED ELEVATOR CAB PLANS, ELEVATIONS AND RCPS BASE BID, BID OPTION 2 & 3
*	ENLARGED ELEVATOR CAB PLANS, ELEVATIONS AND RCPS BID OPTIONS 4, 5 & 6
Al203	ENLARGED ELEVATOR CAB PLANS, ELEVATIONS AND RCPS, BASE BID & BID OPTIONS 2 & 3 ALT PANEL LAYOUTS
Al204	ENLARGED ELEVATOR CAB PLANS, ELEVATIONS AND RCPS BID OPTIONS 4, 5 & 6 ALT PANEL LAYOUTS
Al601	DOOR AND FINISH SCHEDULE, FINISH LEGEND AND NOTES
MECHANICAL	
MH-4.01	HVAC BASE OPTION
MH-4.02	HVAC OPTION 2
MH-4.03	HVAC OPTION 3
MH-4.04	HVAC OPTION 4
MH-4.05	HVAC OPTION 5
ELECTRICAL	
E0.01	ELECTRICAL LEGEND & GENERAL NOTES
E4.01	ELECTRICAL BASE BID
E4.02	ELECTRICAL BASE BID
E4.03	ELECTRICAL OPTION 2
E4.04	ELECTRICAL OPTION 3
E4.05	ELECTRICAL OPTION 4
E4.06	ELECTRICAL OPTION 5
E4.07	ELECTRICAL OPTION 6

VAMC **PROVIDENCE** 

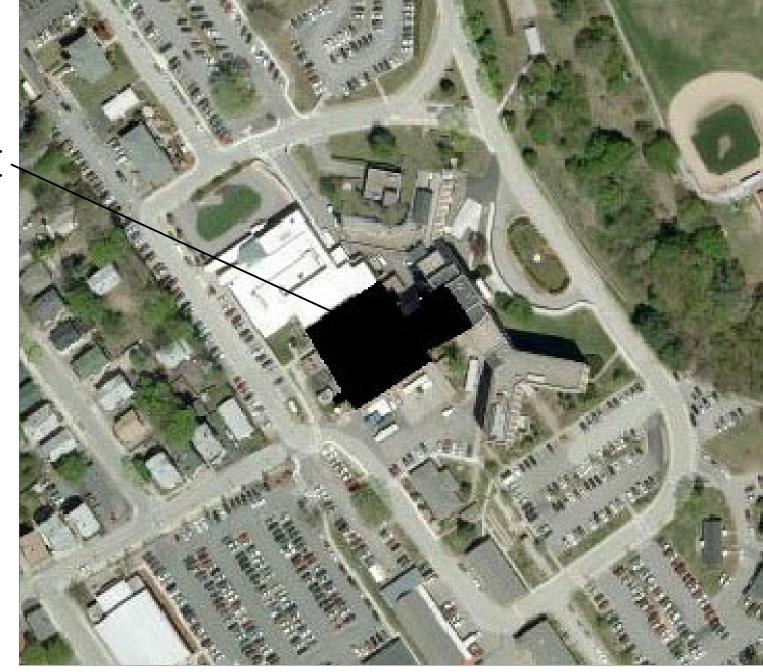

Location Map

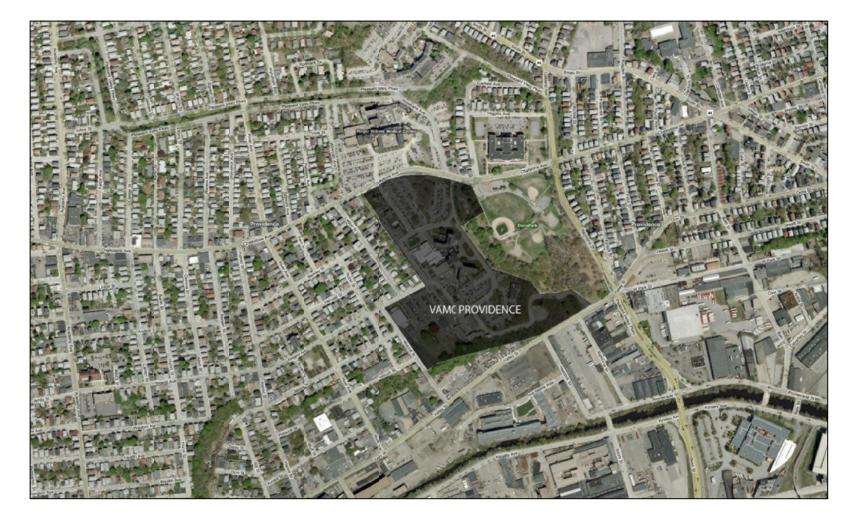



Vicinity Map





# ISSUE FOR CONSTRUCTION FULLY SPRINKLERED

Drawing Title Project Title ARCHITECT: Office of 650-10-106 Elevator Upgrades and Modernization GENERAL DATA AND INFO Construction **Building Number** MEP/FP Engineers: Environmental Engineers | Vertical Transportation Specialist and Facilities C D w Approved: Project Director Drawing Number Management VDA (Van Deusen & Associates) CDW Consultants, Inc. Thompson Consultants, Inc. Lim Consultants, Inc VAMC PROVIDENCE, RI 02980 40 Speen Street Suite 301 Independence Wharf G1002 525 Mill Street HDR Architecture, Inc. Drawn Framingham, MA 01701 Checked Cambridge, MA 02139 Marion, MA 02738 470 Atlantic Avenue, 4th Floor Department of Veterans Affairs 03/23/12 Boston, MA 02210 695 Atlantic Ave | Boston, MA 02111 | 617.357.7700 Dwg. 002 of 030

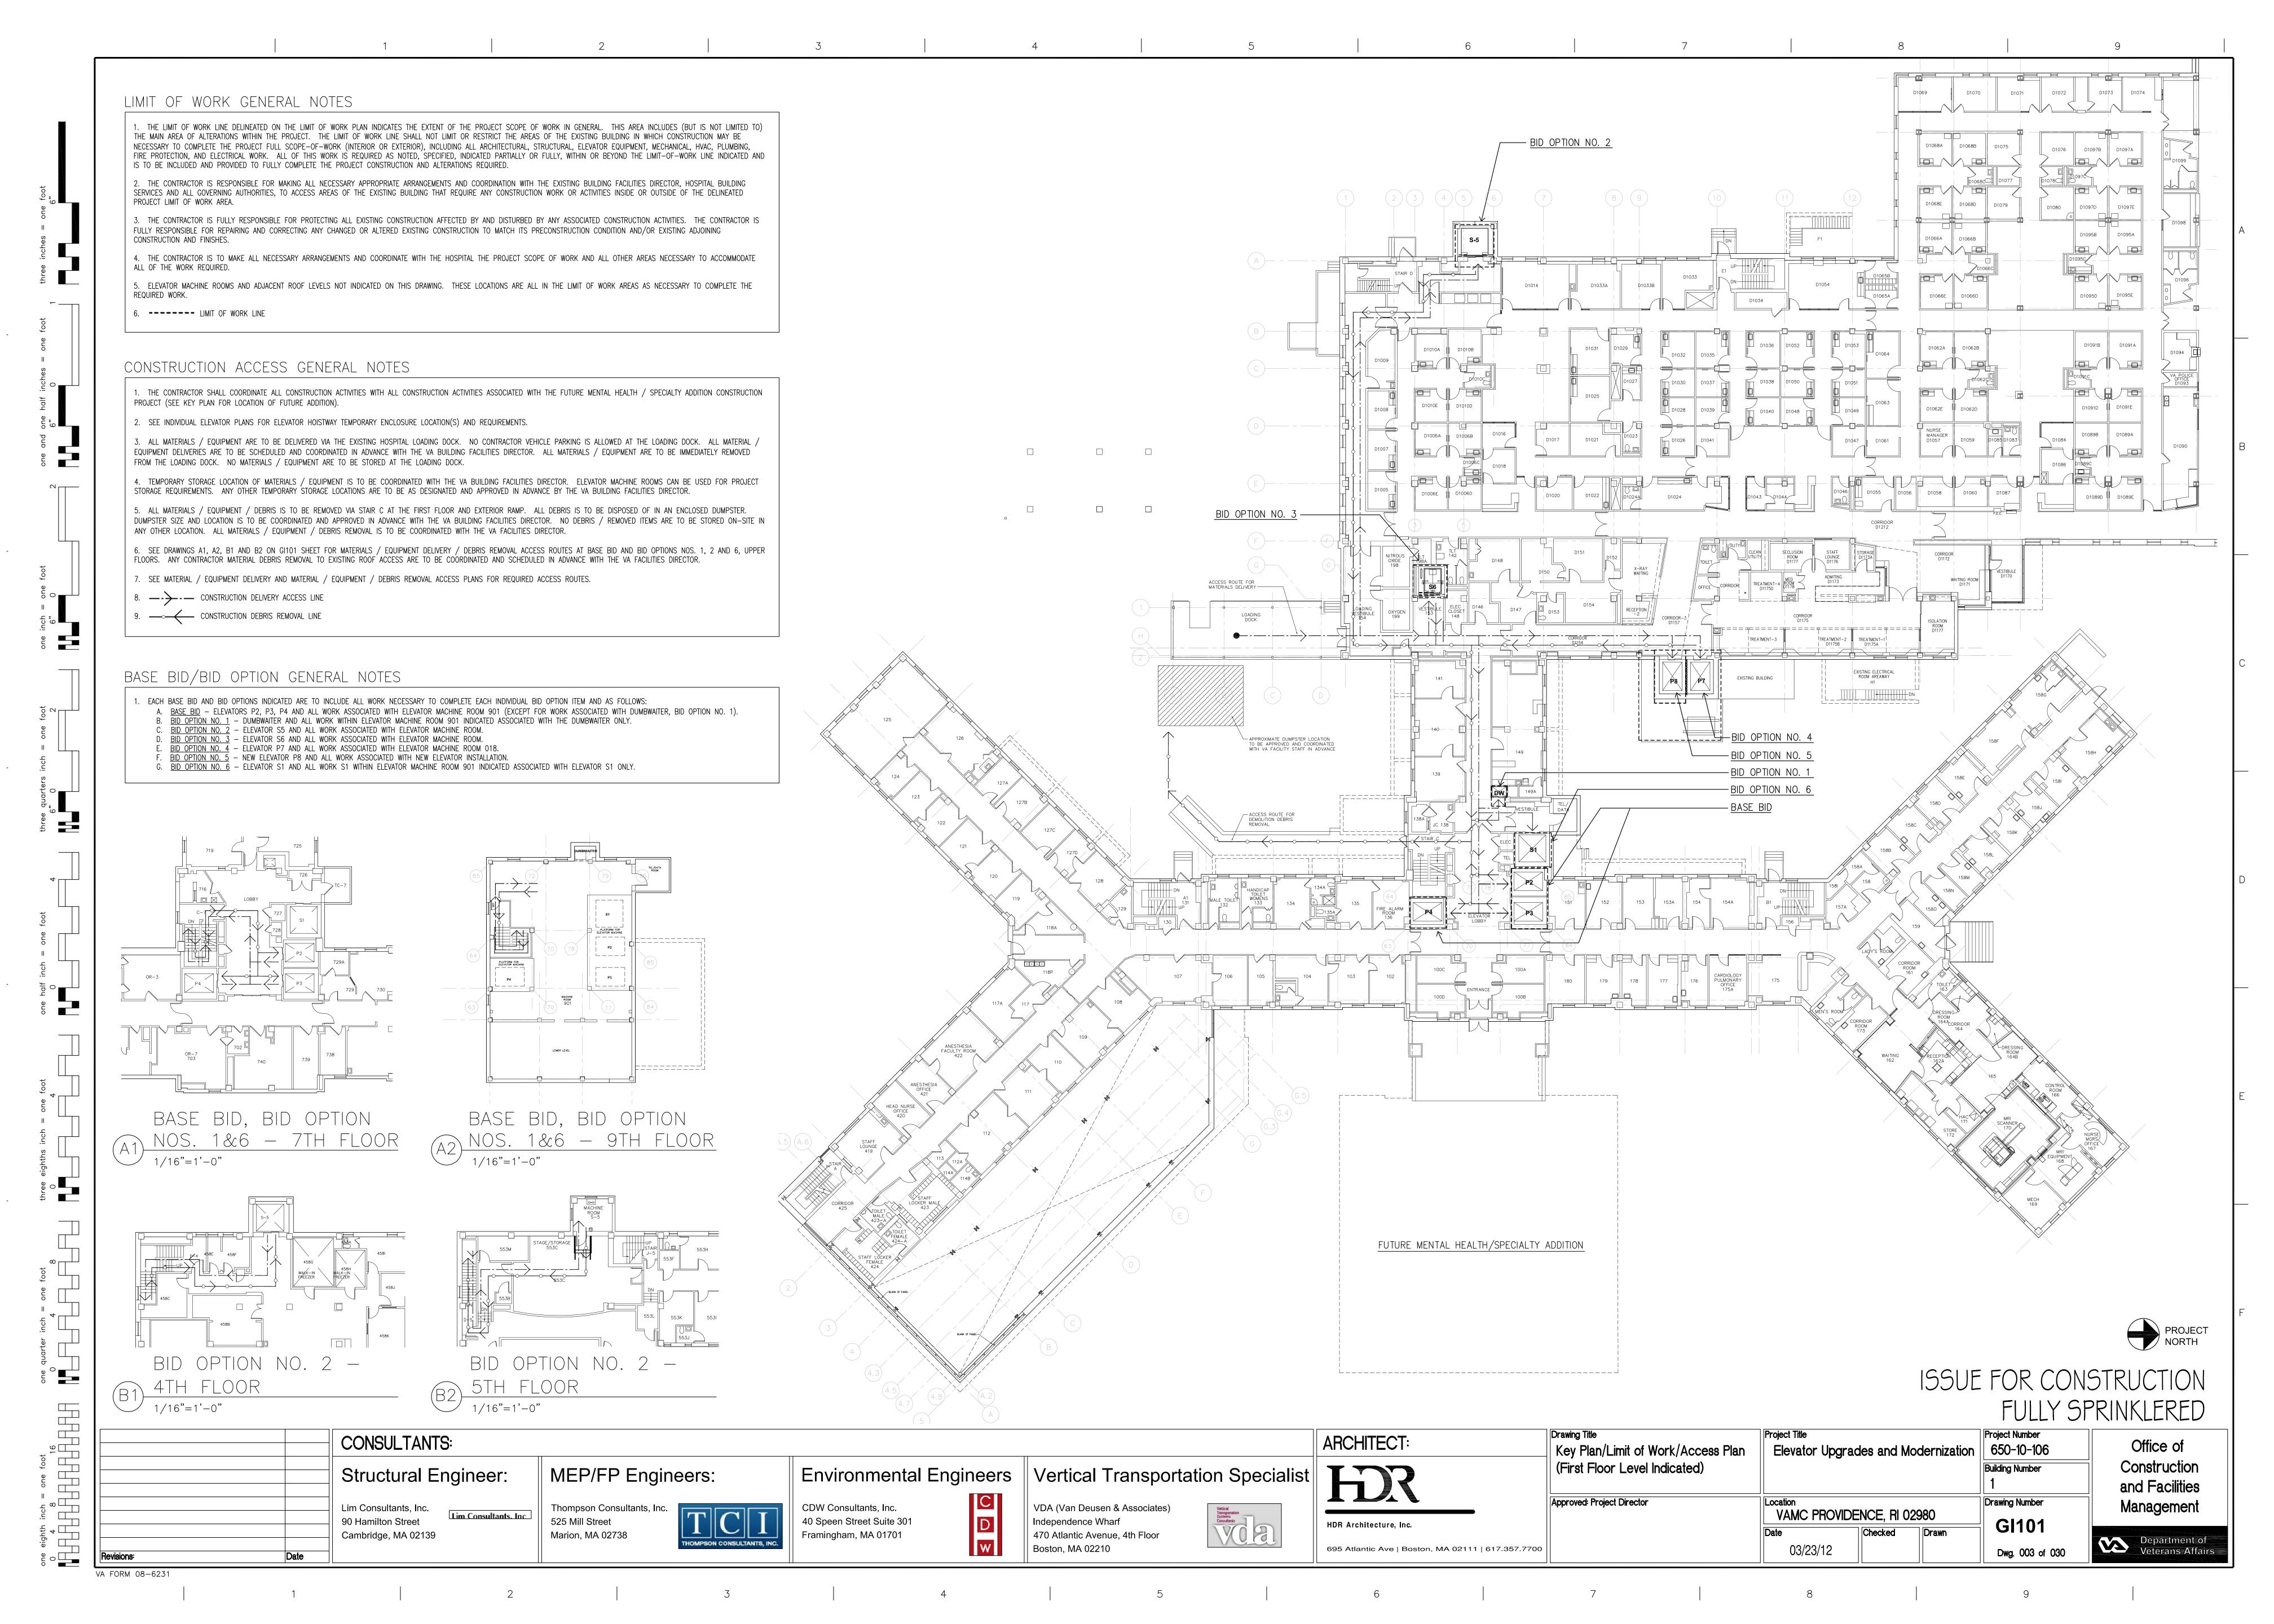

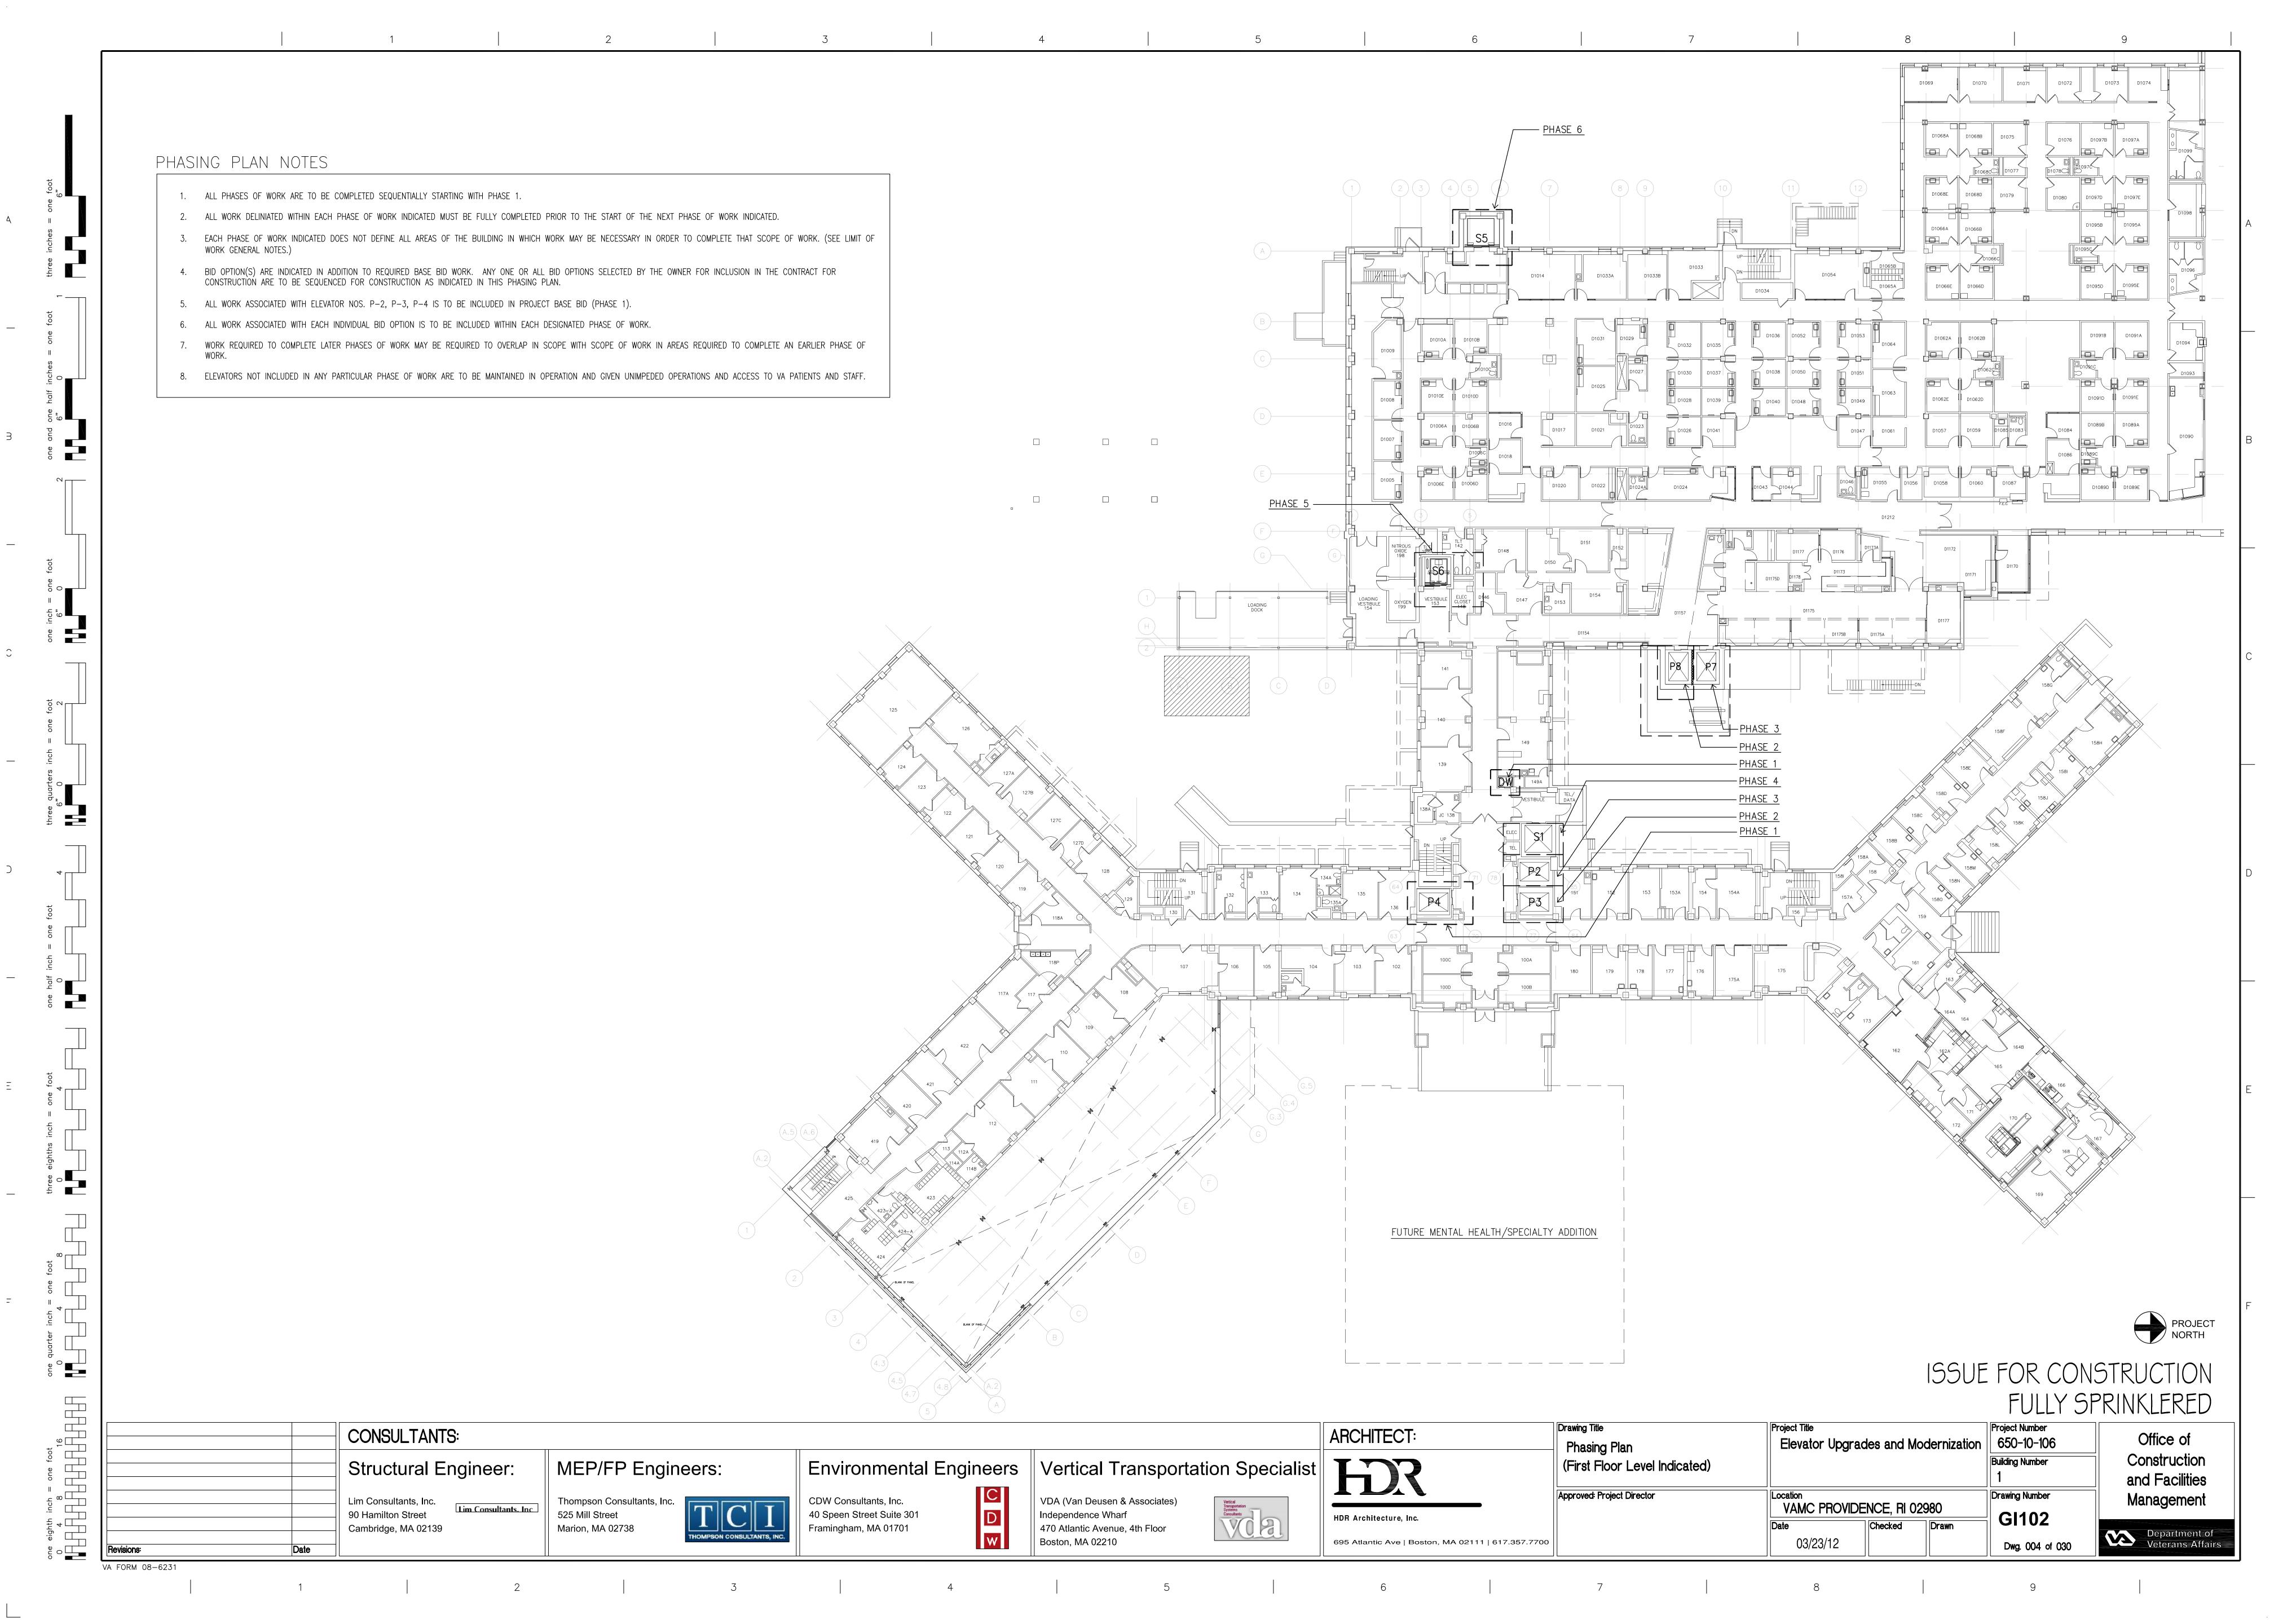

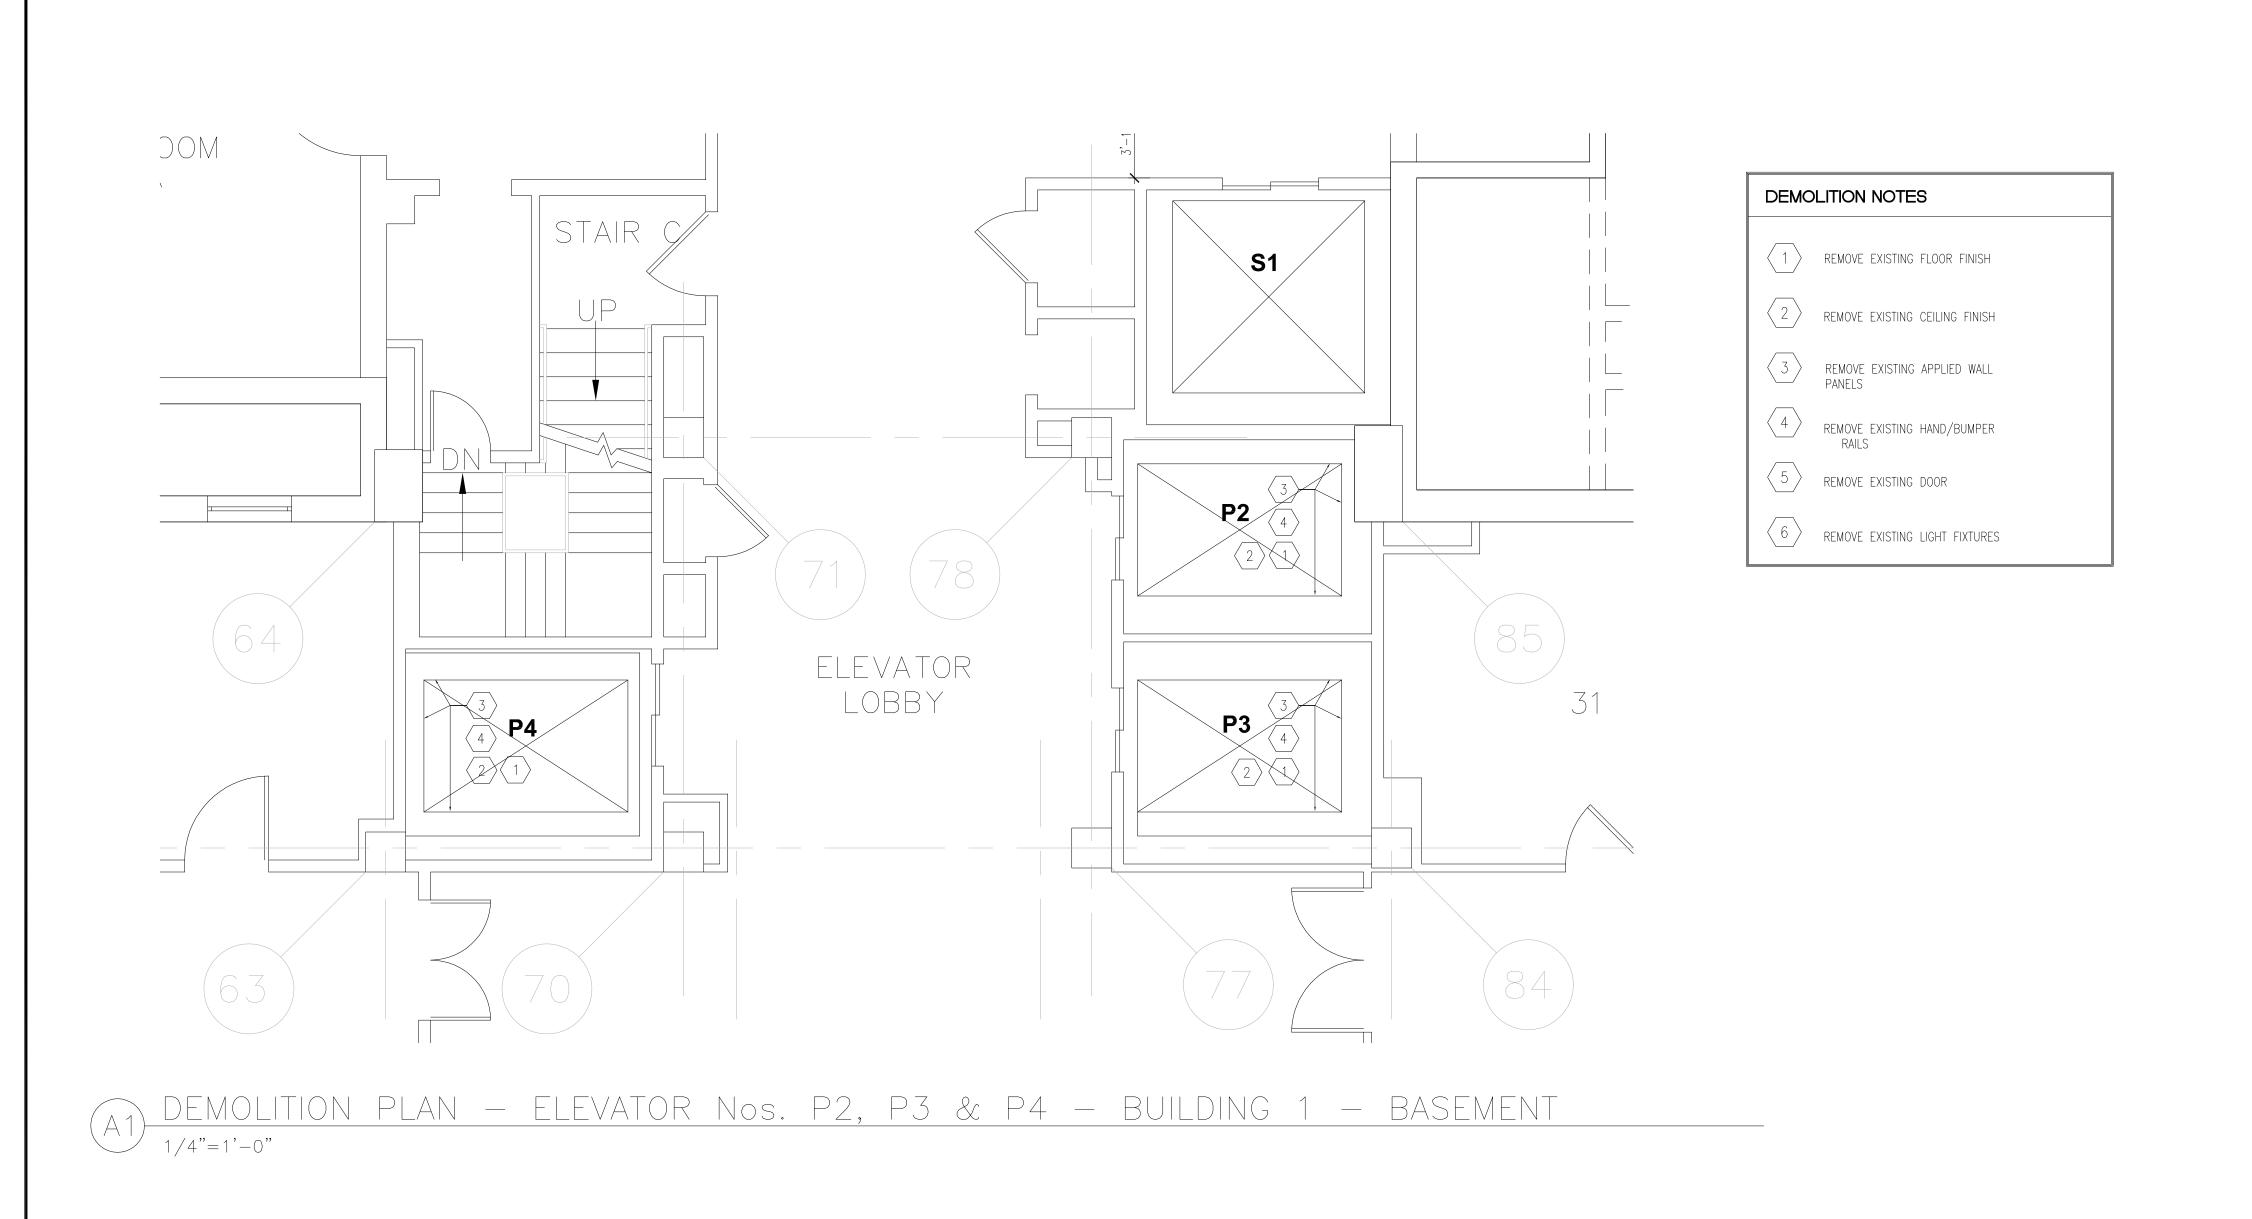

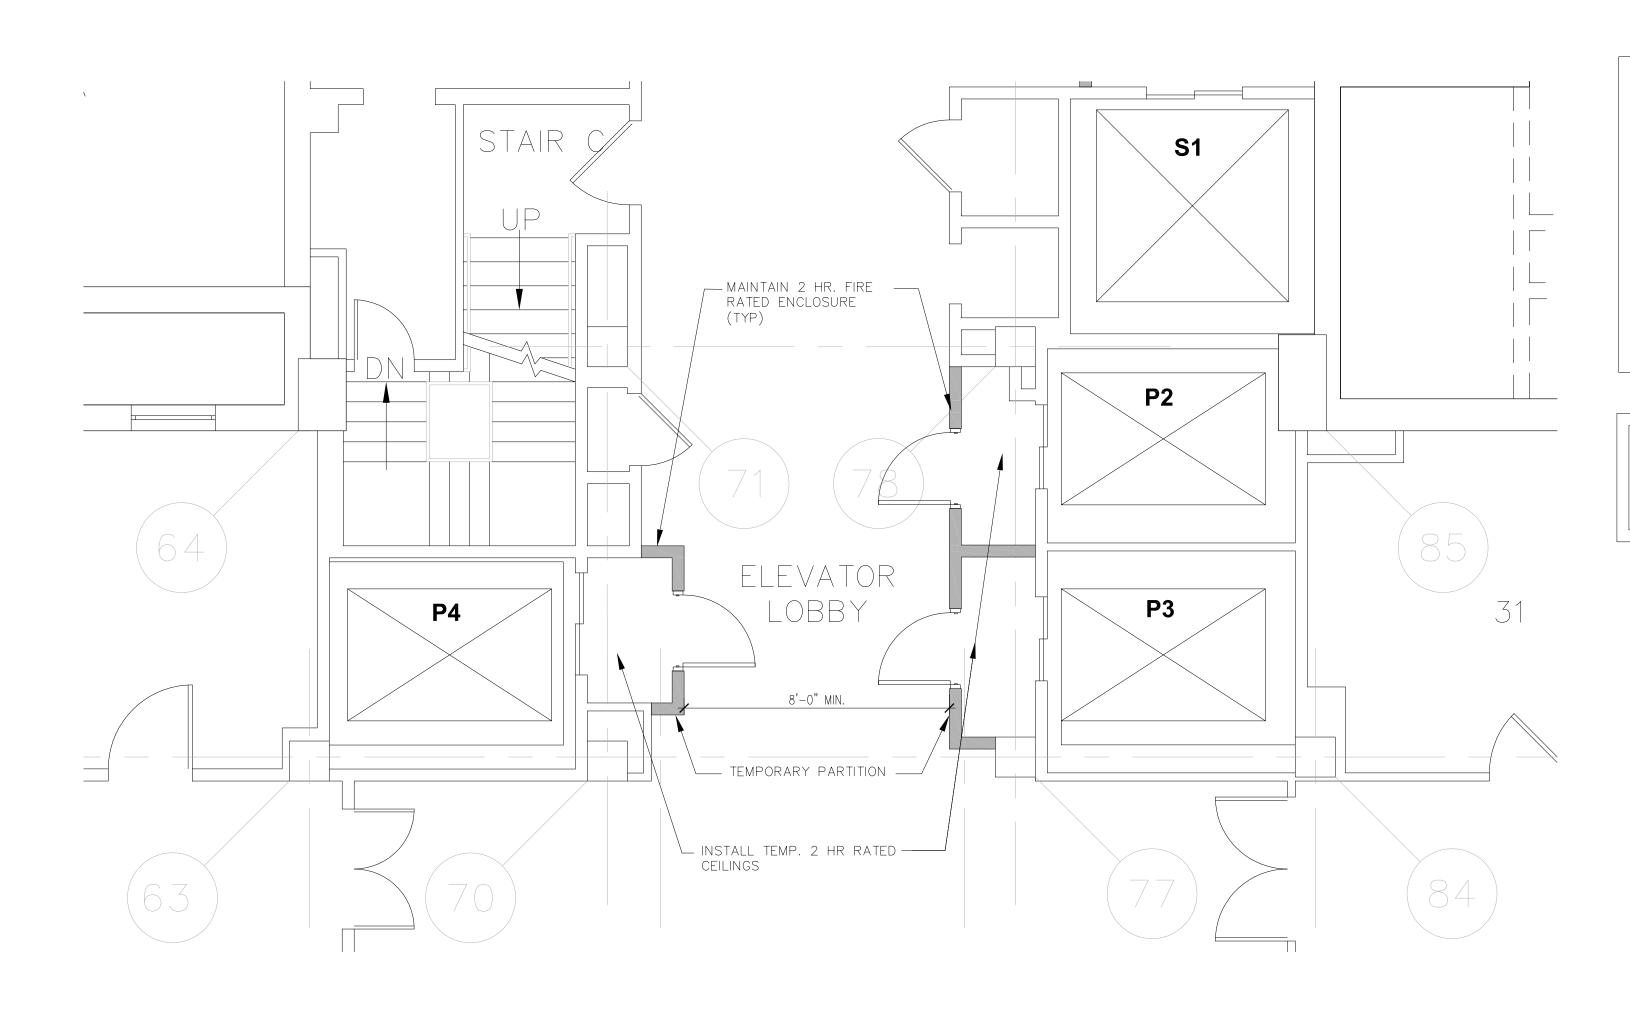


VA FORM 08-6231

Date

NOTE: PROVIDE TEMPORARY PARTITIONS AT FLOOR LEVELS INDICATED. ACCESS TO THE EXISTING HOISTWAYS WILL BE RESTRICTED TO THE FLOOR LEVELS INDICATED WITH TEMPORARY PARTITIONS ONLY.

ALL ELEVATOR AND DUMBWAITER SHAFTS, BY CODE, ARE REQUIRED TO BE 2 HOUR FIRE RATED. ALL THE TEMPORARY ENCLOSURE WALLS IN FRONT OF THE ELEVATOR DOORS SHOULD BE 2 HOUR RATED WITH A 1-1/2HOUR B LABEL DOOR AND FRAME WITH AUTO CLOSER AND LOCKING HARDWARE.

NOTE: SEE PROJECT SPECIFICATIONS, ELEVATOR CAB INTERIOR ELEVATIONS AND CAB FINISH SCHEDULE AND MECH/ELEC DRAWINGS FOR ADDITIONAL INFORMATION REGARDING REQUIRED PROJECT SCOPE-OF-WORK.

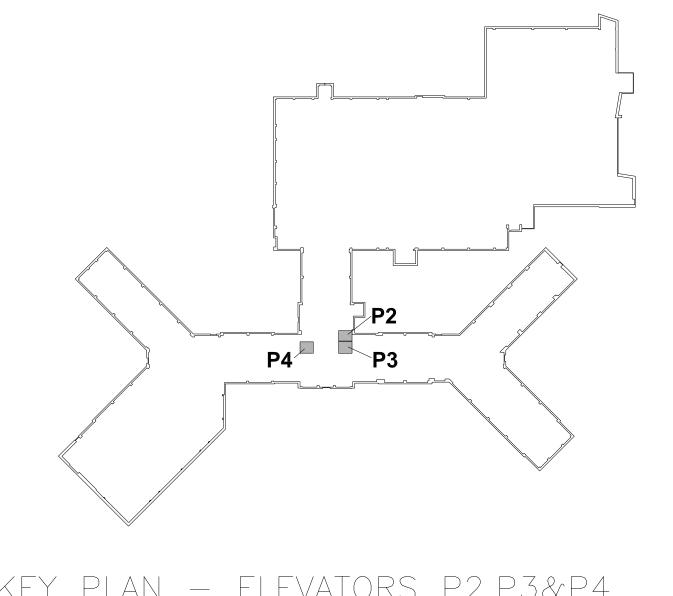

KEY PLAN - ELEVATORS P2,P3&P4 BUILDING 1 - (BASE BID)

N.T.S.

# ISSUE FOR CONSTRUCTION FULLY SPRINKLERED

B1 RENOVATION 1/4"=1'-0"	J PLA	N - ELEVATOR Nos.	P2, P3 & P4 - BUILDING	G 1 — BASEMENT	
		CONSULTANTS:			
		Structural Engineer:	MEP/FP Engineers:	Environmental Engineers	Vertical Transportation Speciali
Revisions:	Date	Lim Consultants, Inc. 90 Hamilton Street Cambridge, MA 02139	Thompson Consultants, Inc. 525 Mill Street Marion, MA 02738  THOMPSON CONSULTANTS, INC.	CDW Consultants, Inc. 40 Speen Street Suite 301 Framingham, MA 01701	VDA (Van Deusen & Associates) Independence Wharf 470 Atlantic Avenue, 4th Floor Boston, MA 02210

VOZ


ARCHITECT:


HDR Architecture, Inc. 695 Atlantic Ave | Boston, MA 02111 | 617.357.7700


Project Title Project Number Drawing Title
PLANS Elevator Upgrades and Modernization 650-10-106 Elevator Nos. P2, P3 and P4 Building Number (Base Bid) Approved: Project Director Drawing Number VAMC PROVIDENCE, RI 02980 **AS101** Checked Drawn CLH 03/23/12 HL Dwg. 005 of 030


Office of Construction and Facilities Management Department of Veterans Affairs


PROJECT NORTH

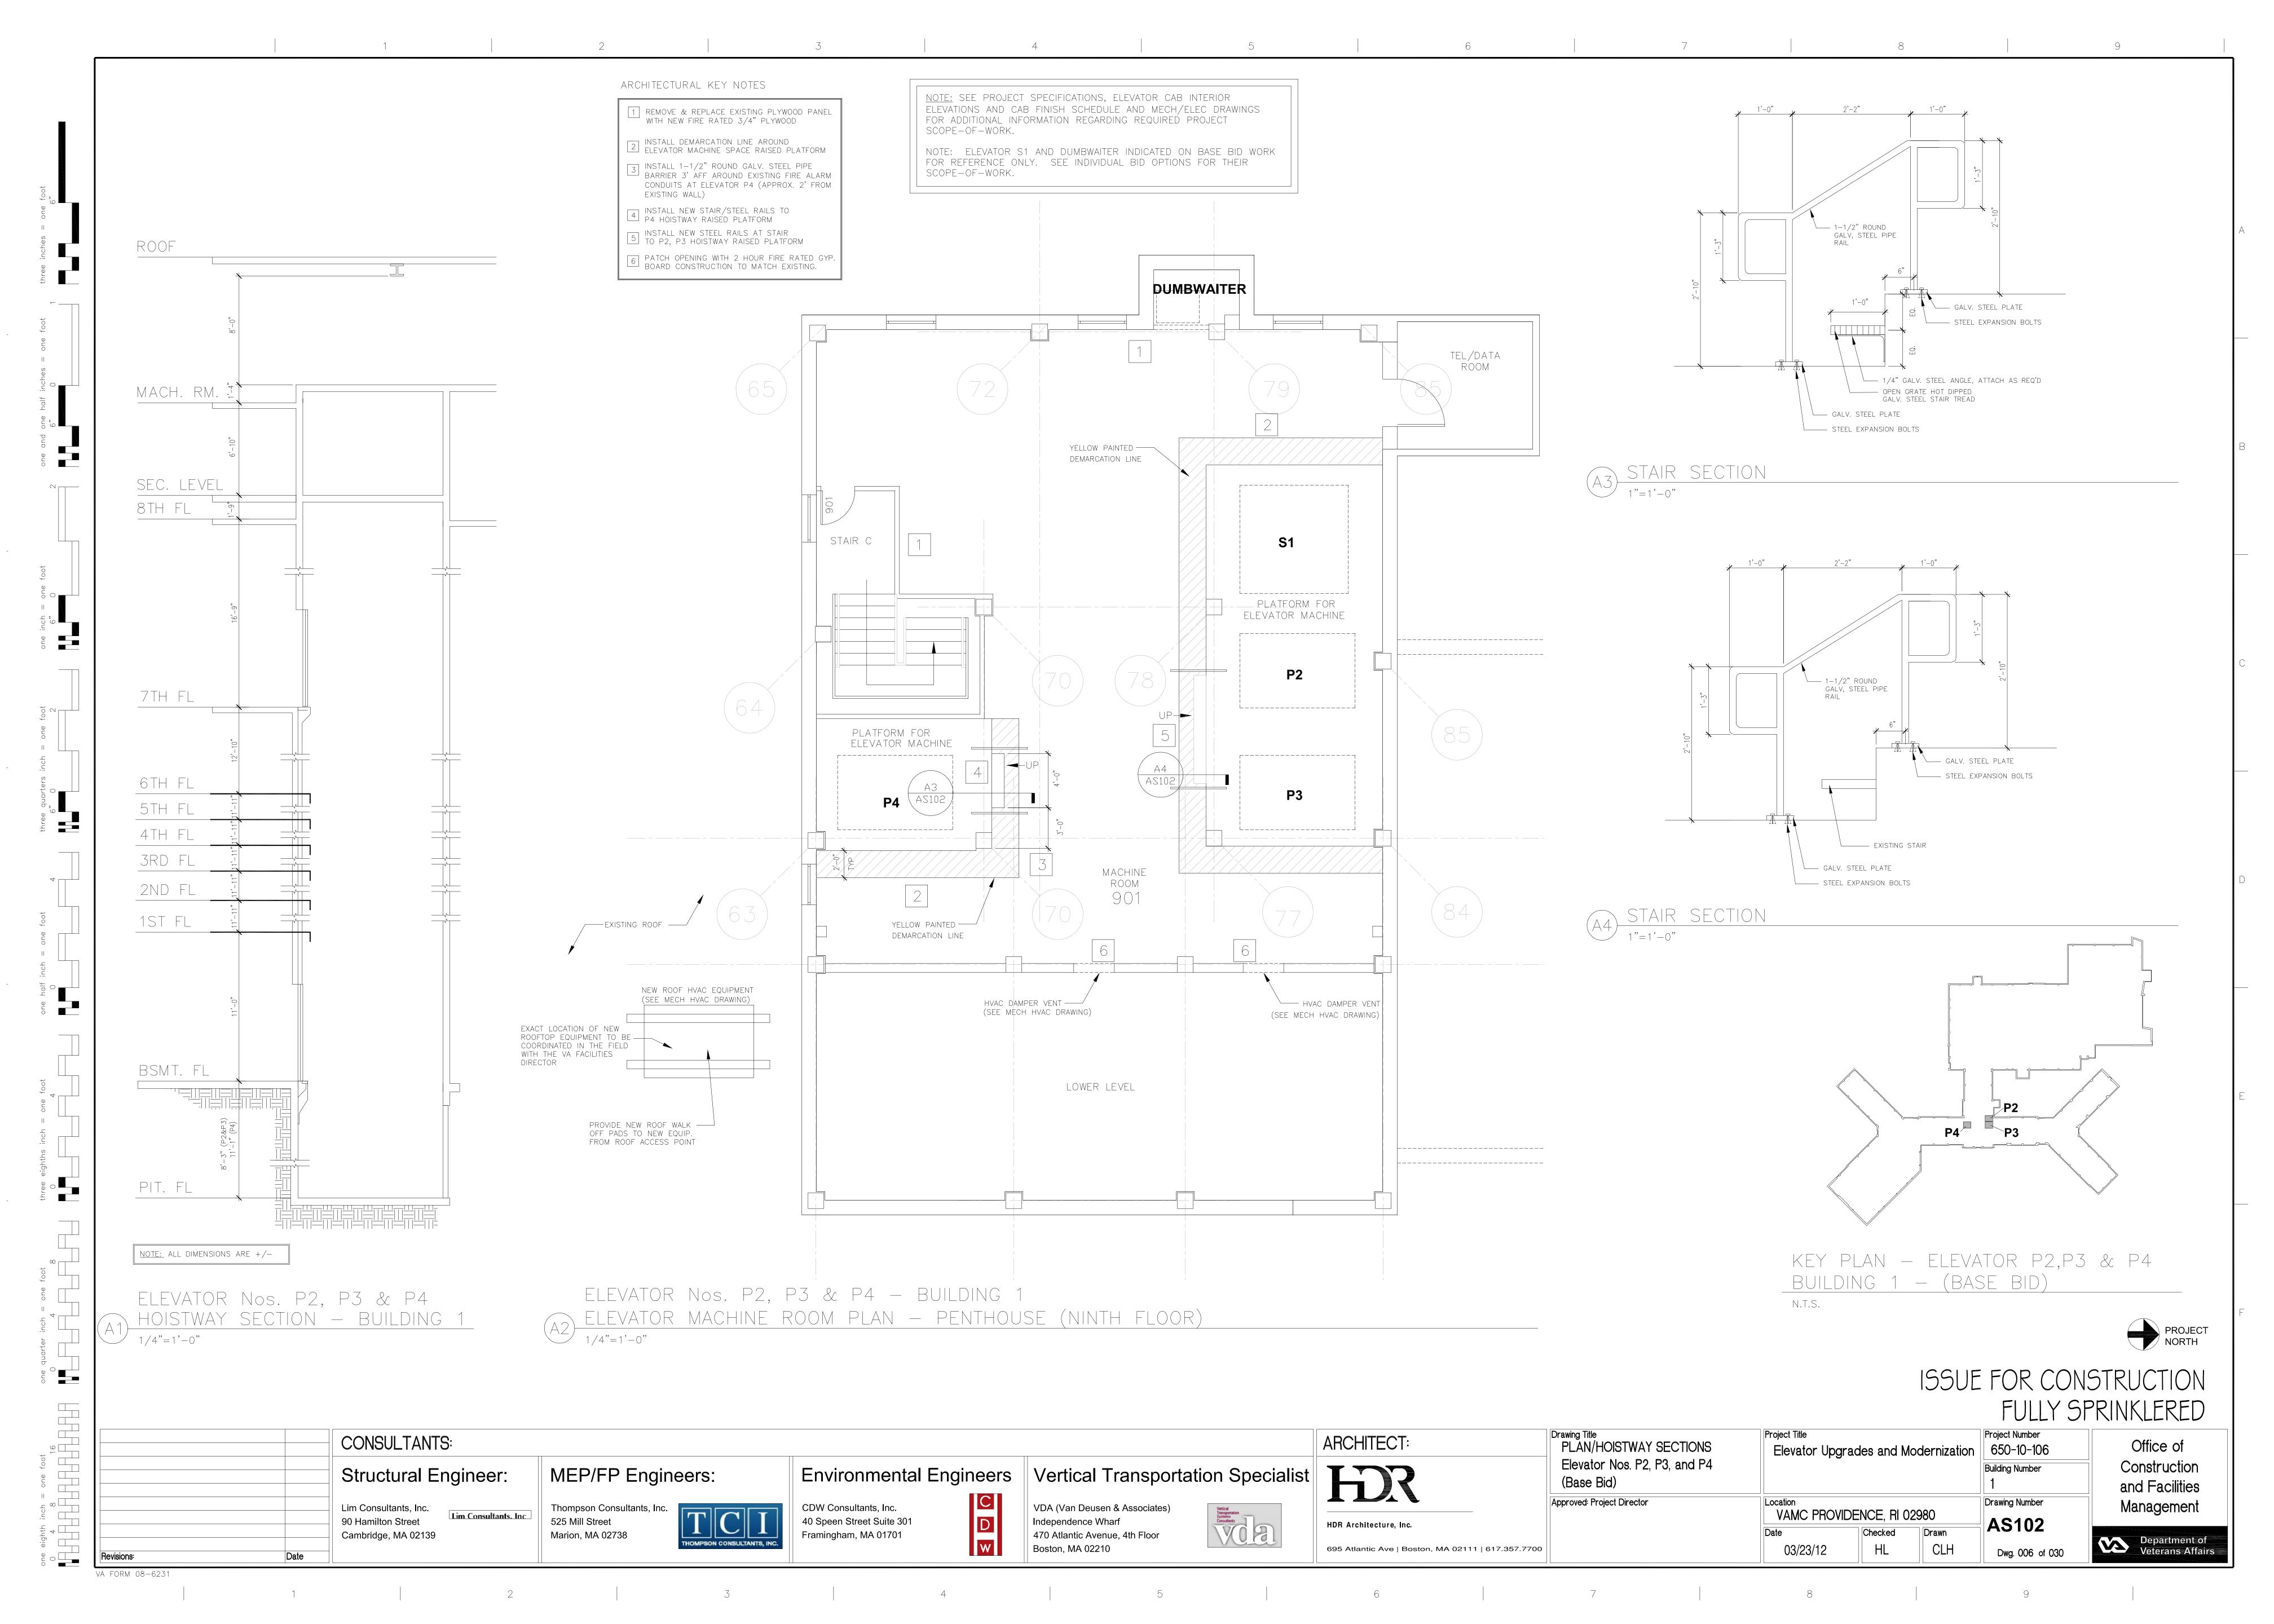


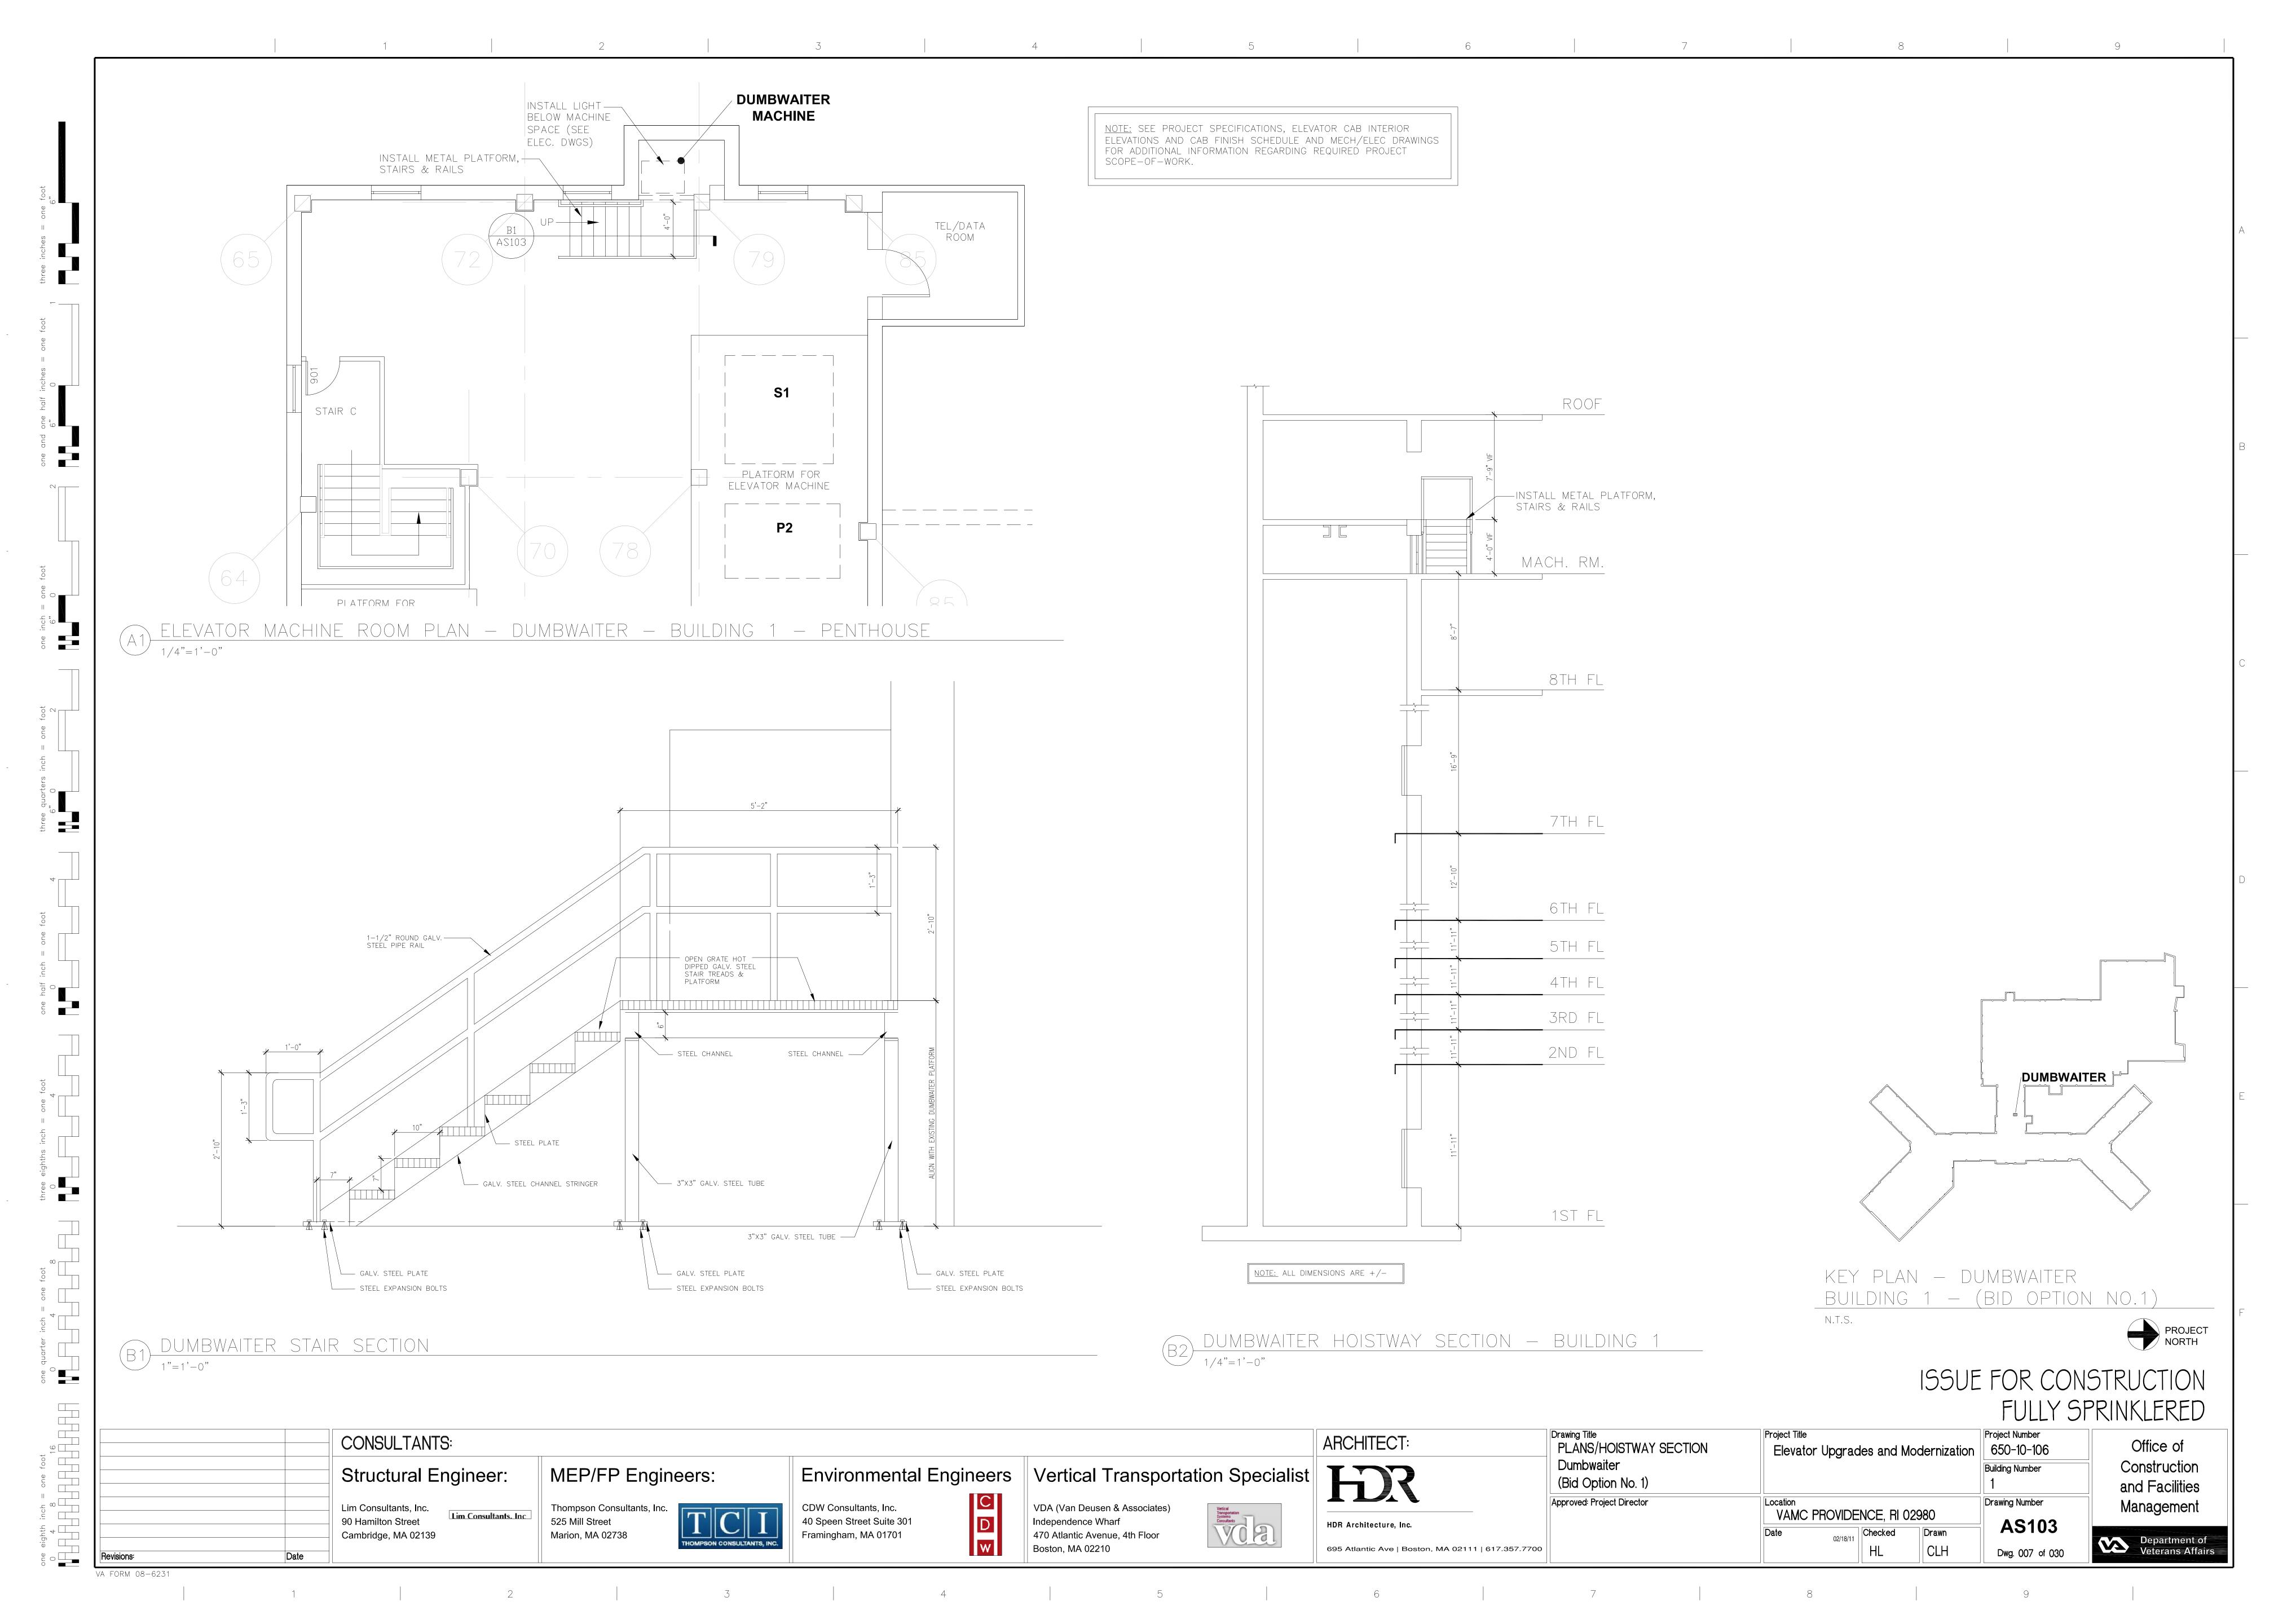


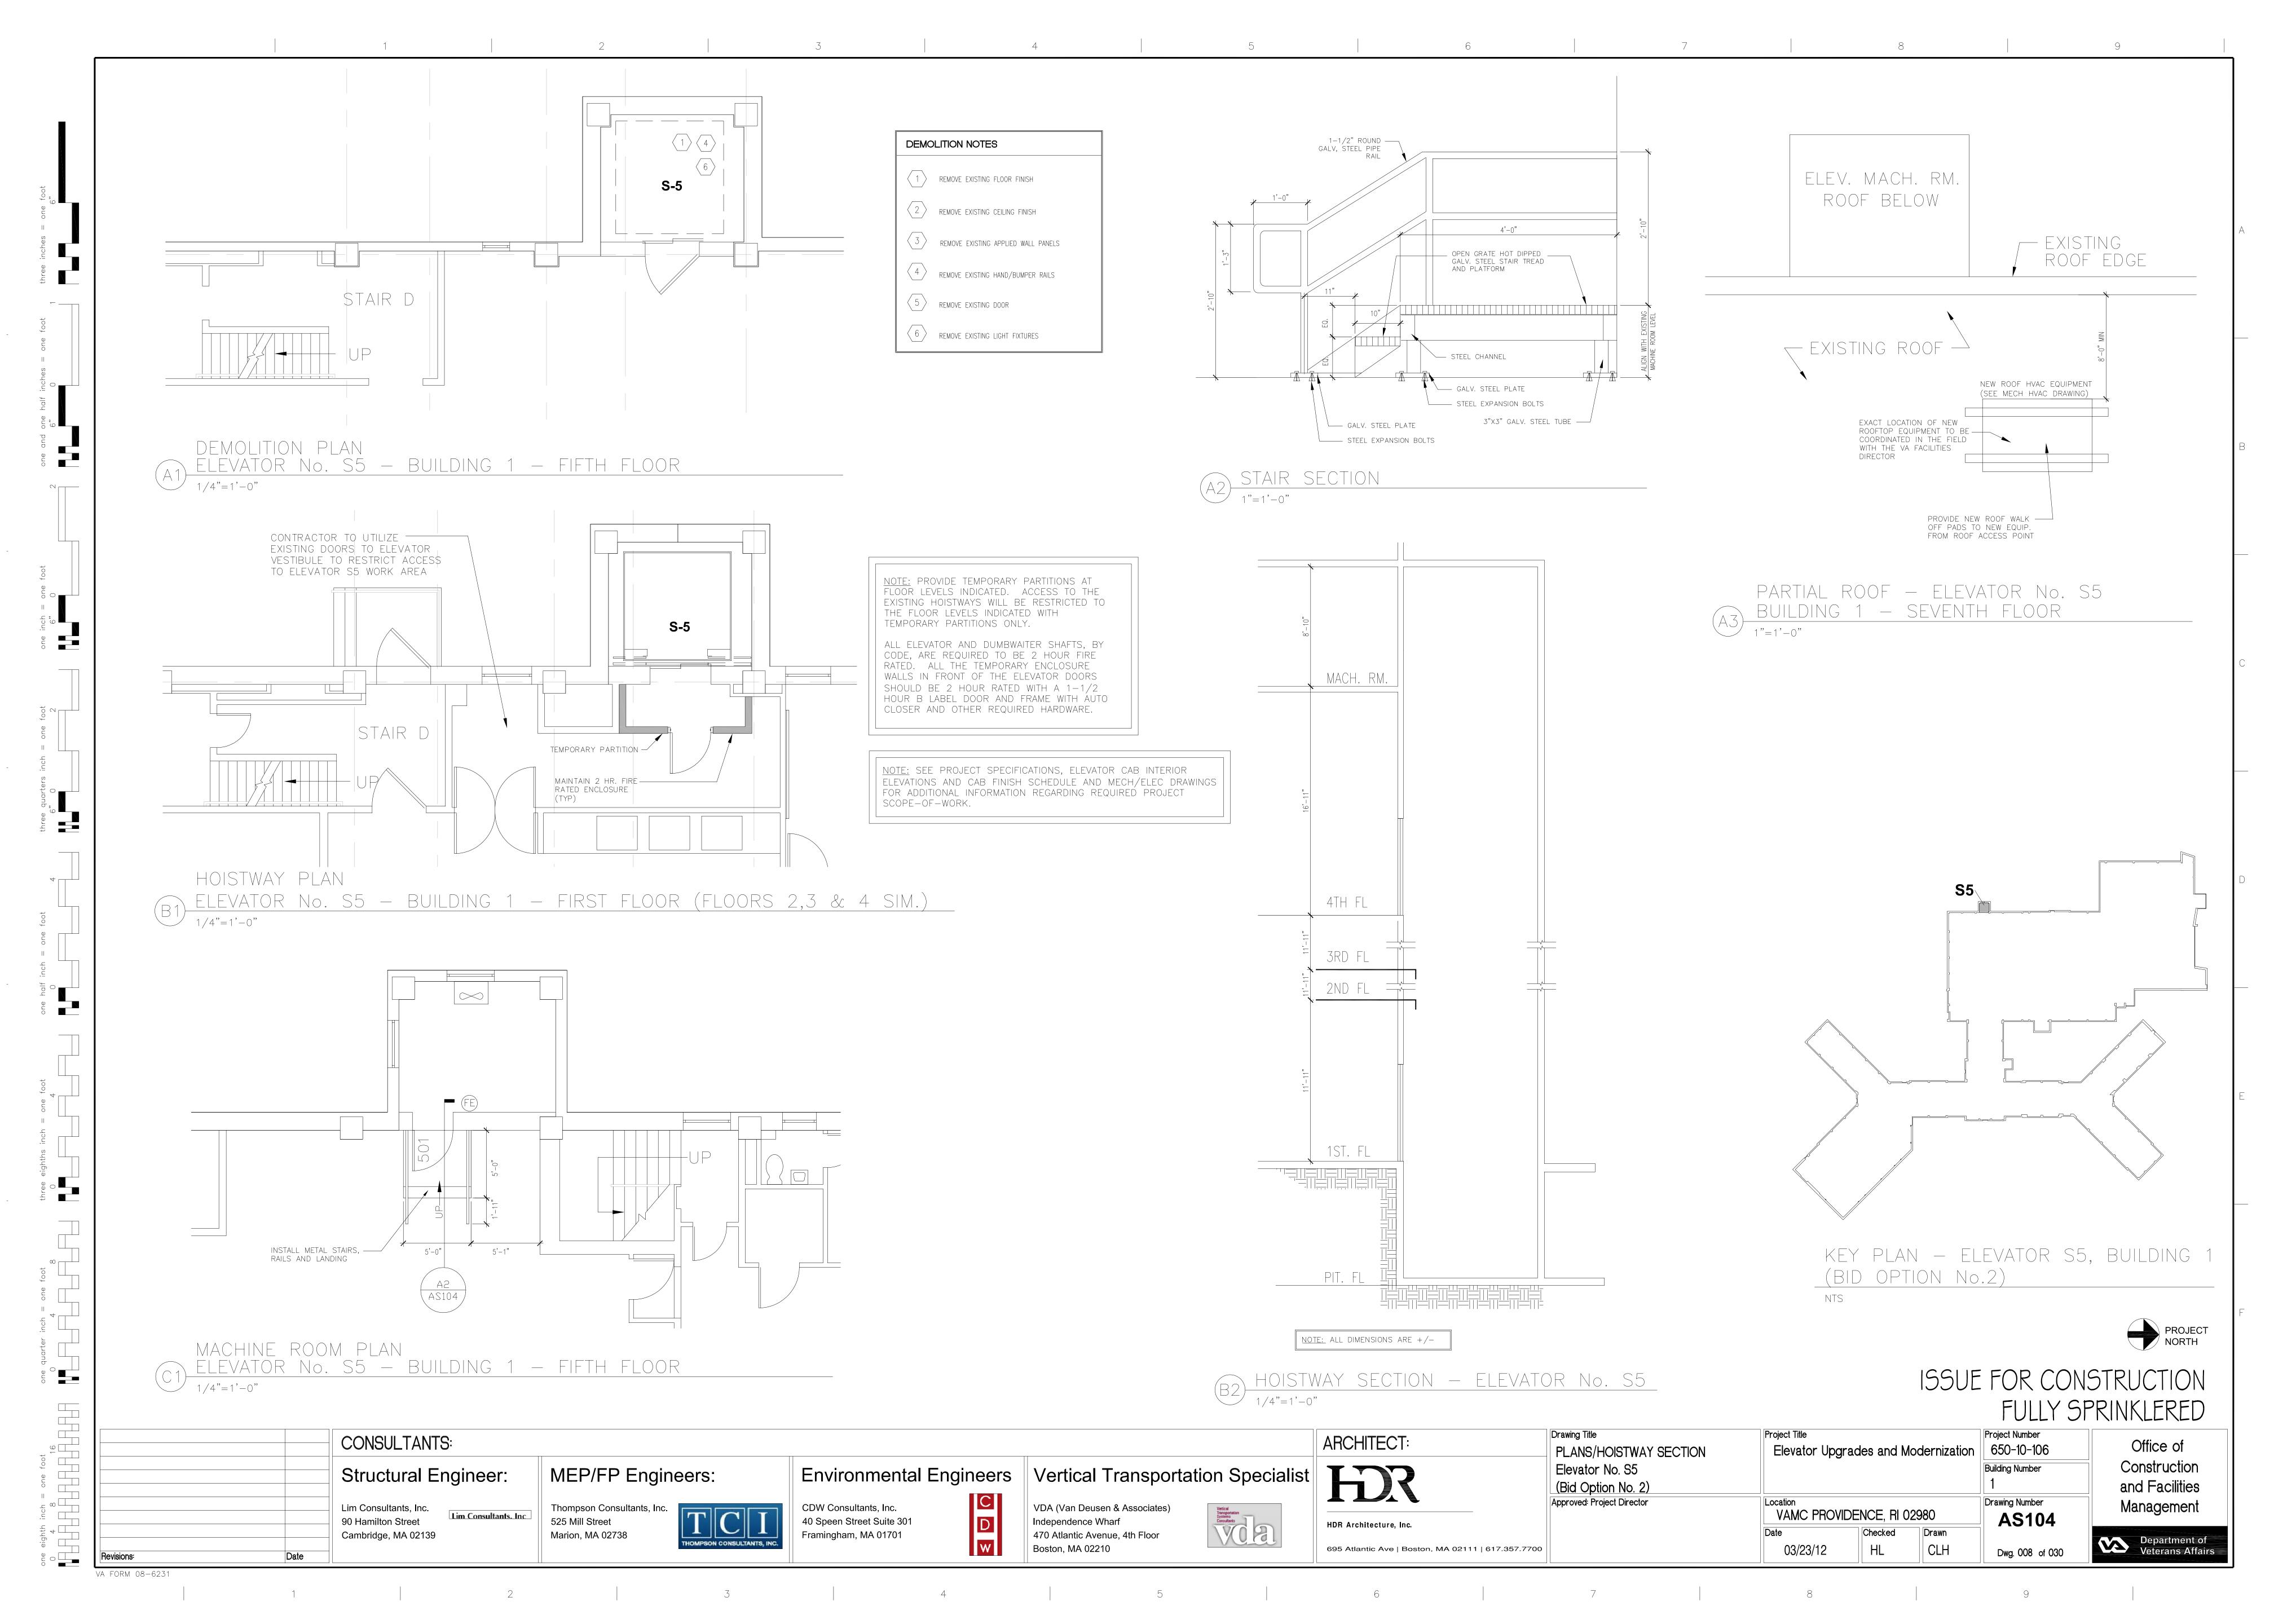


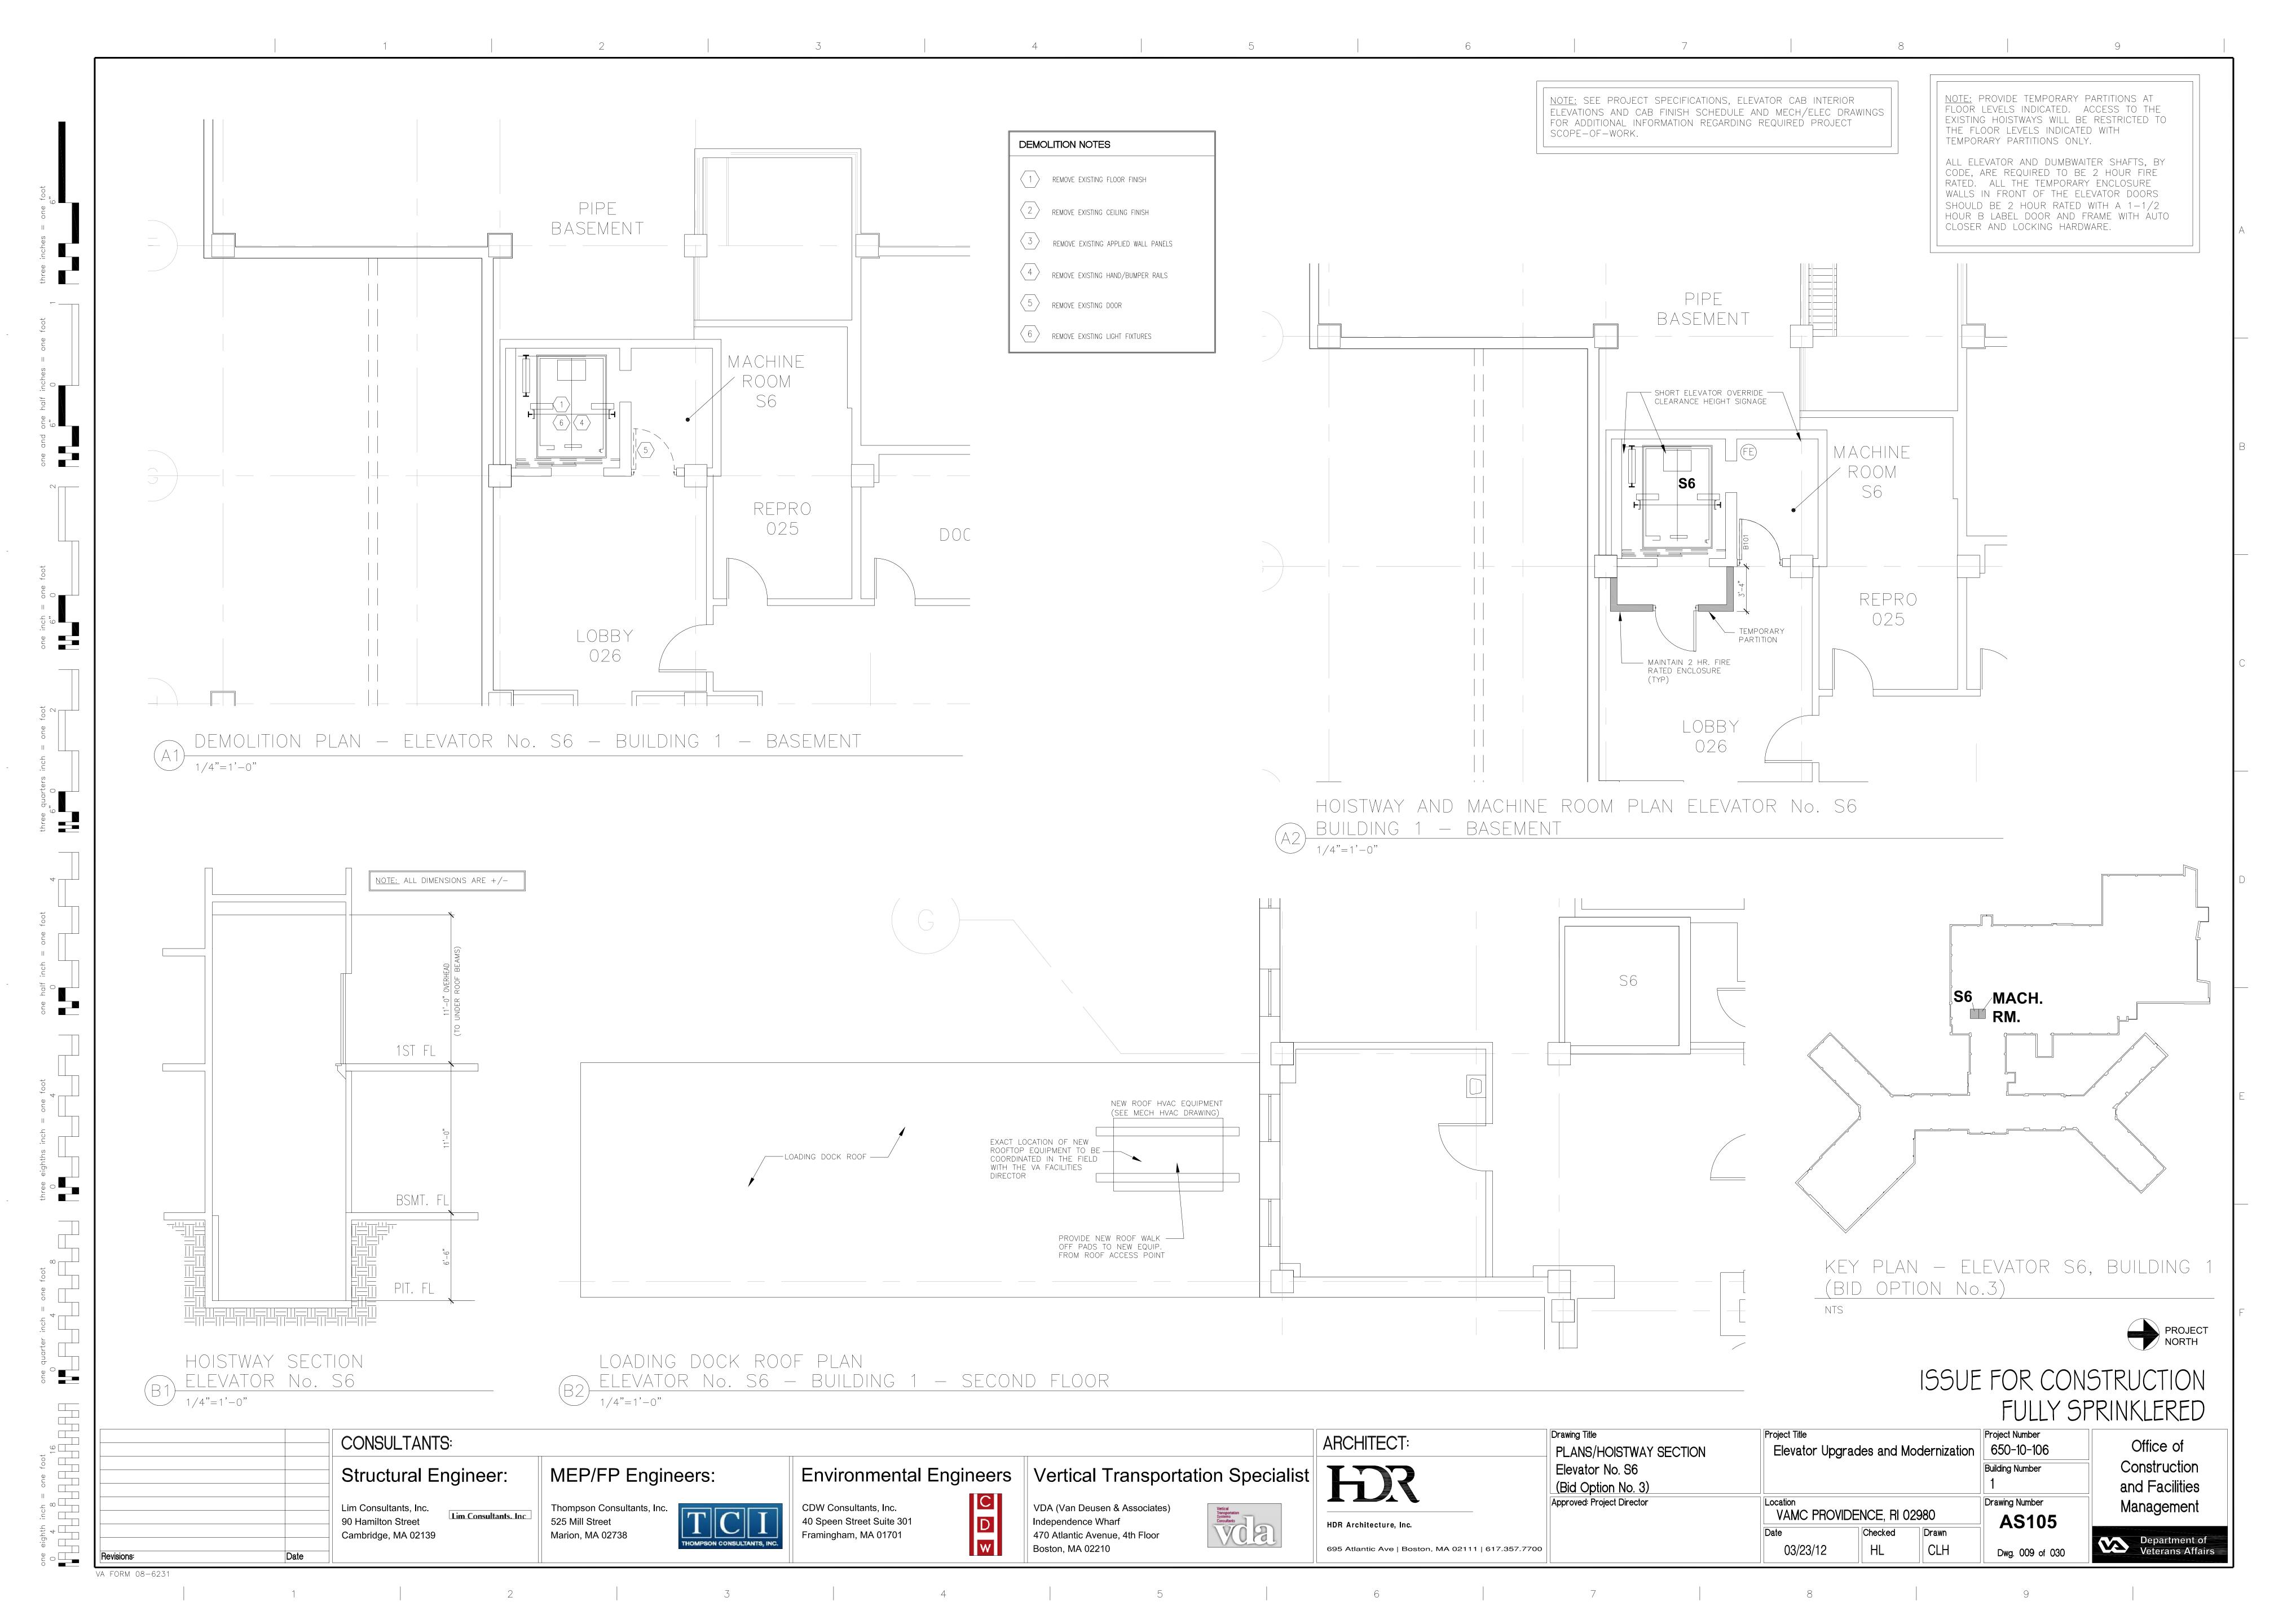


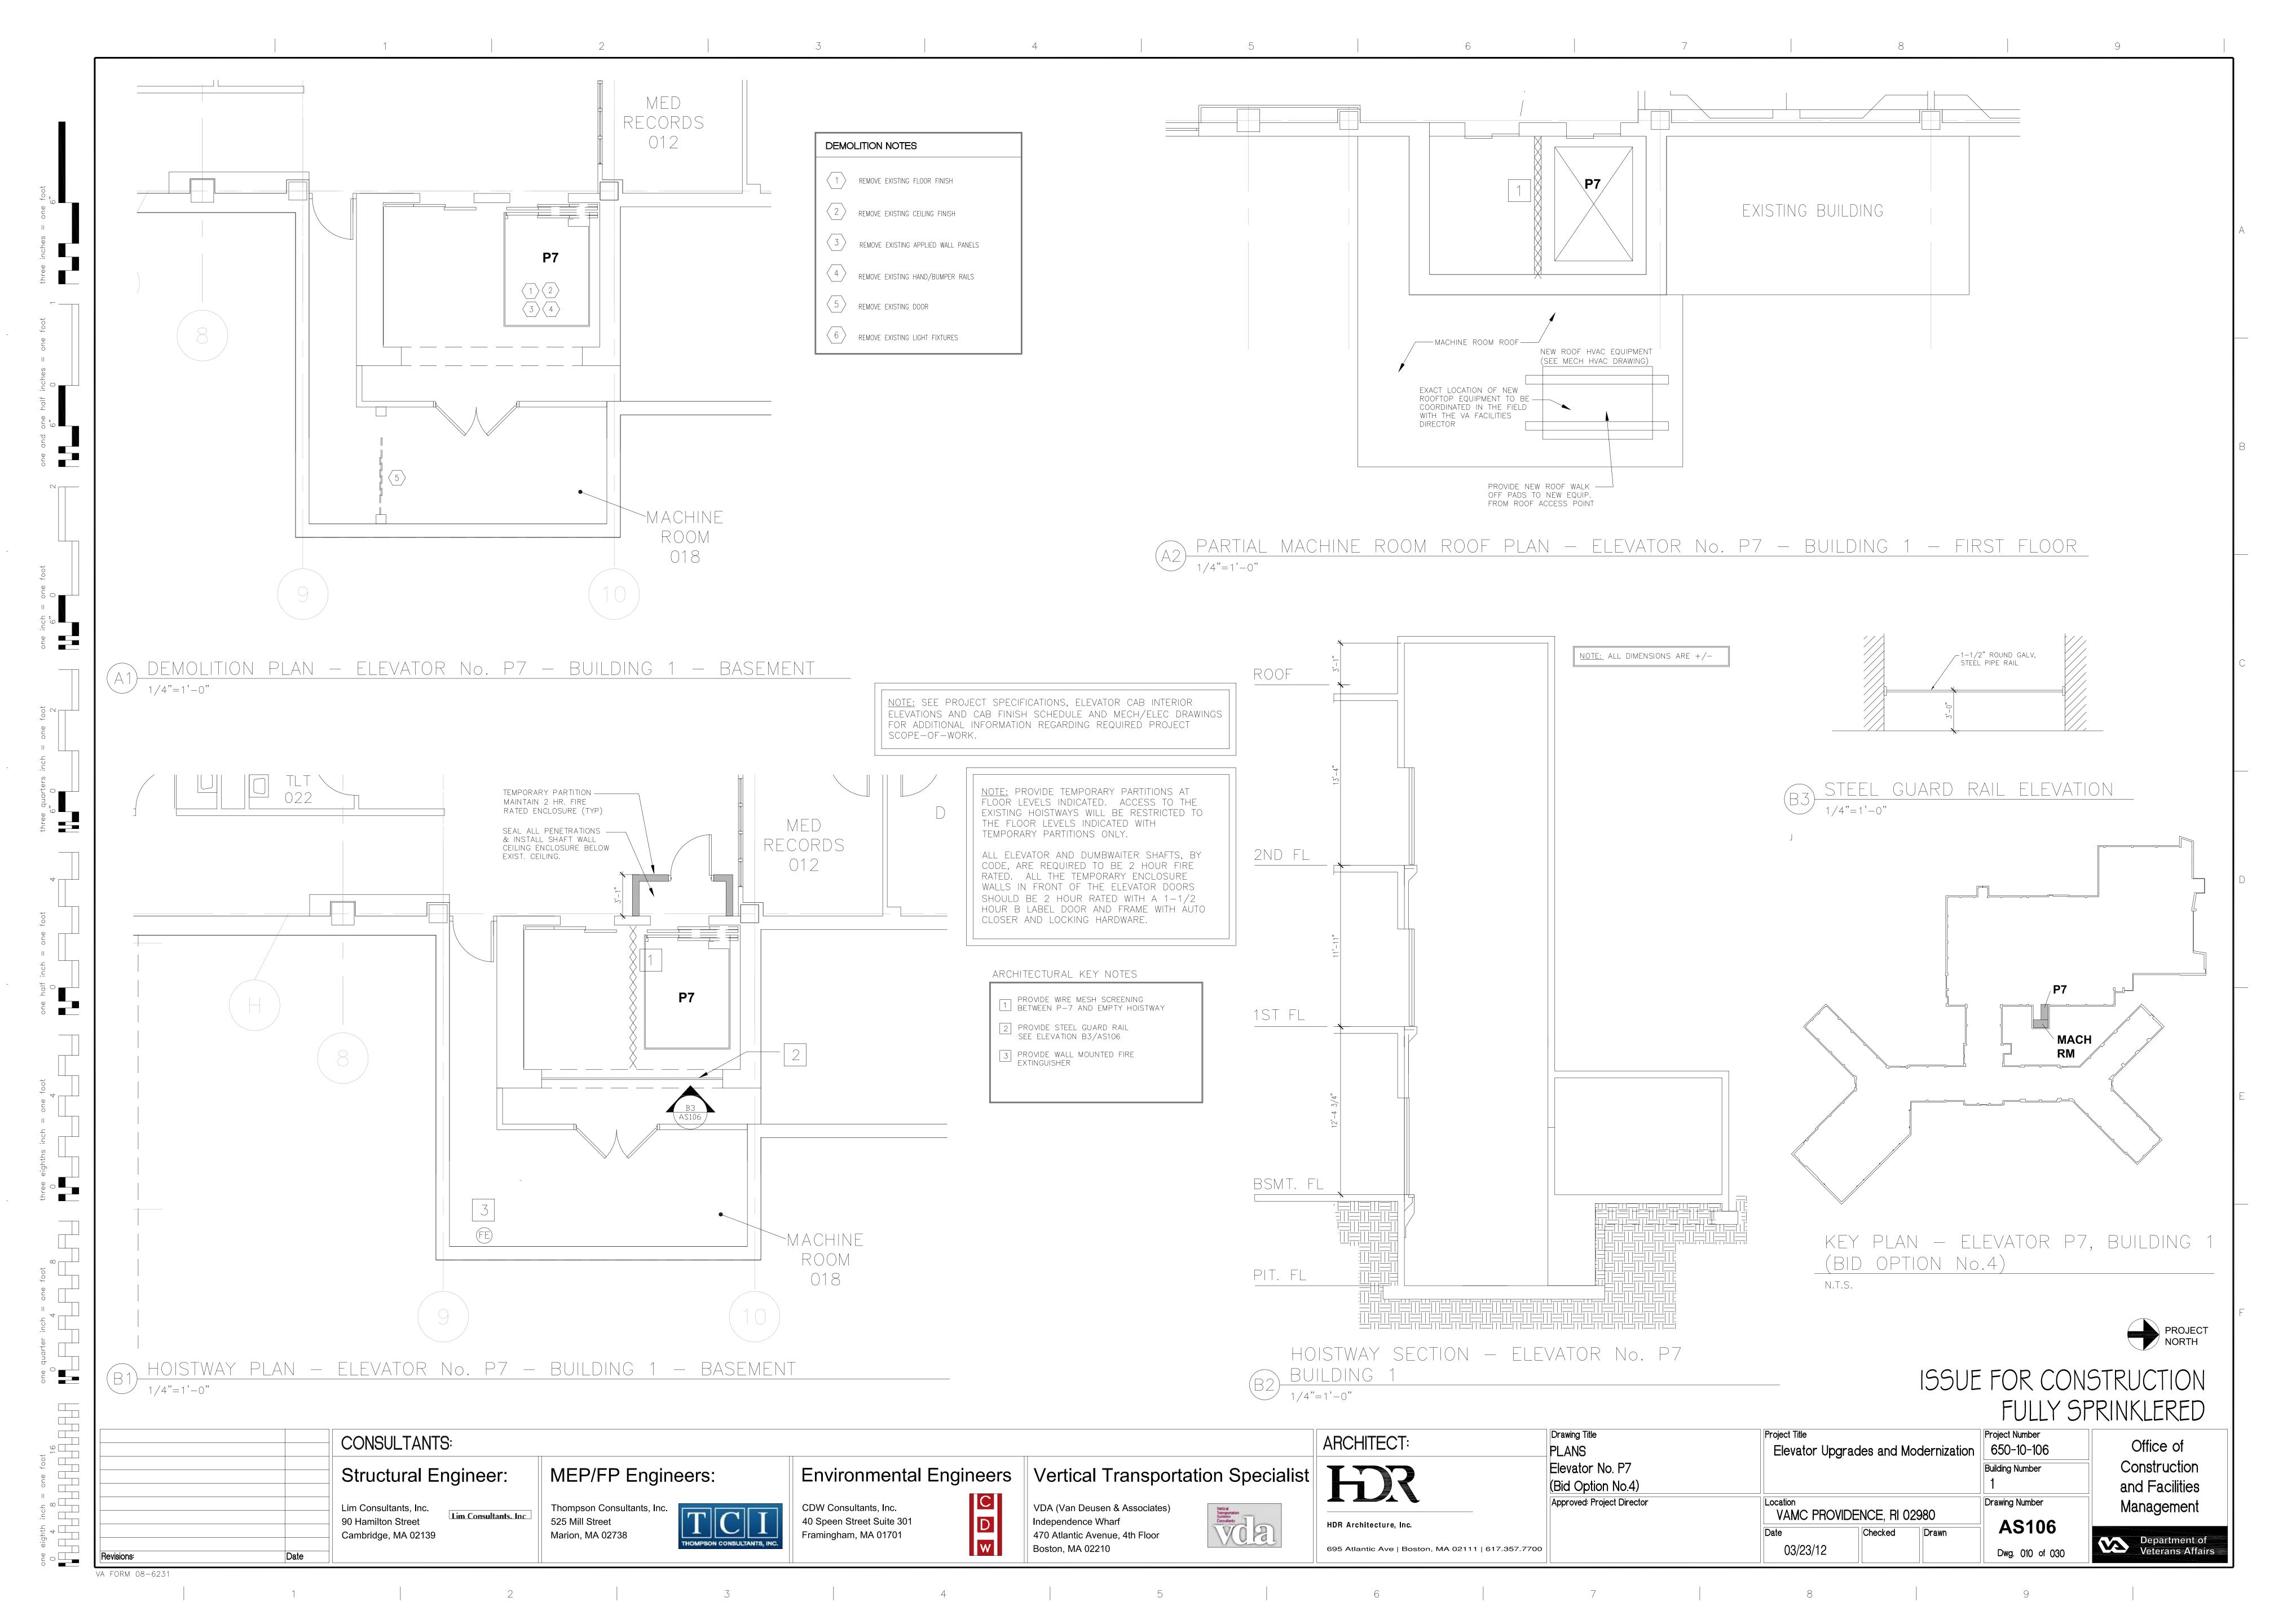


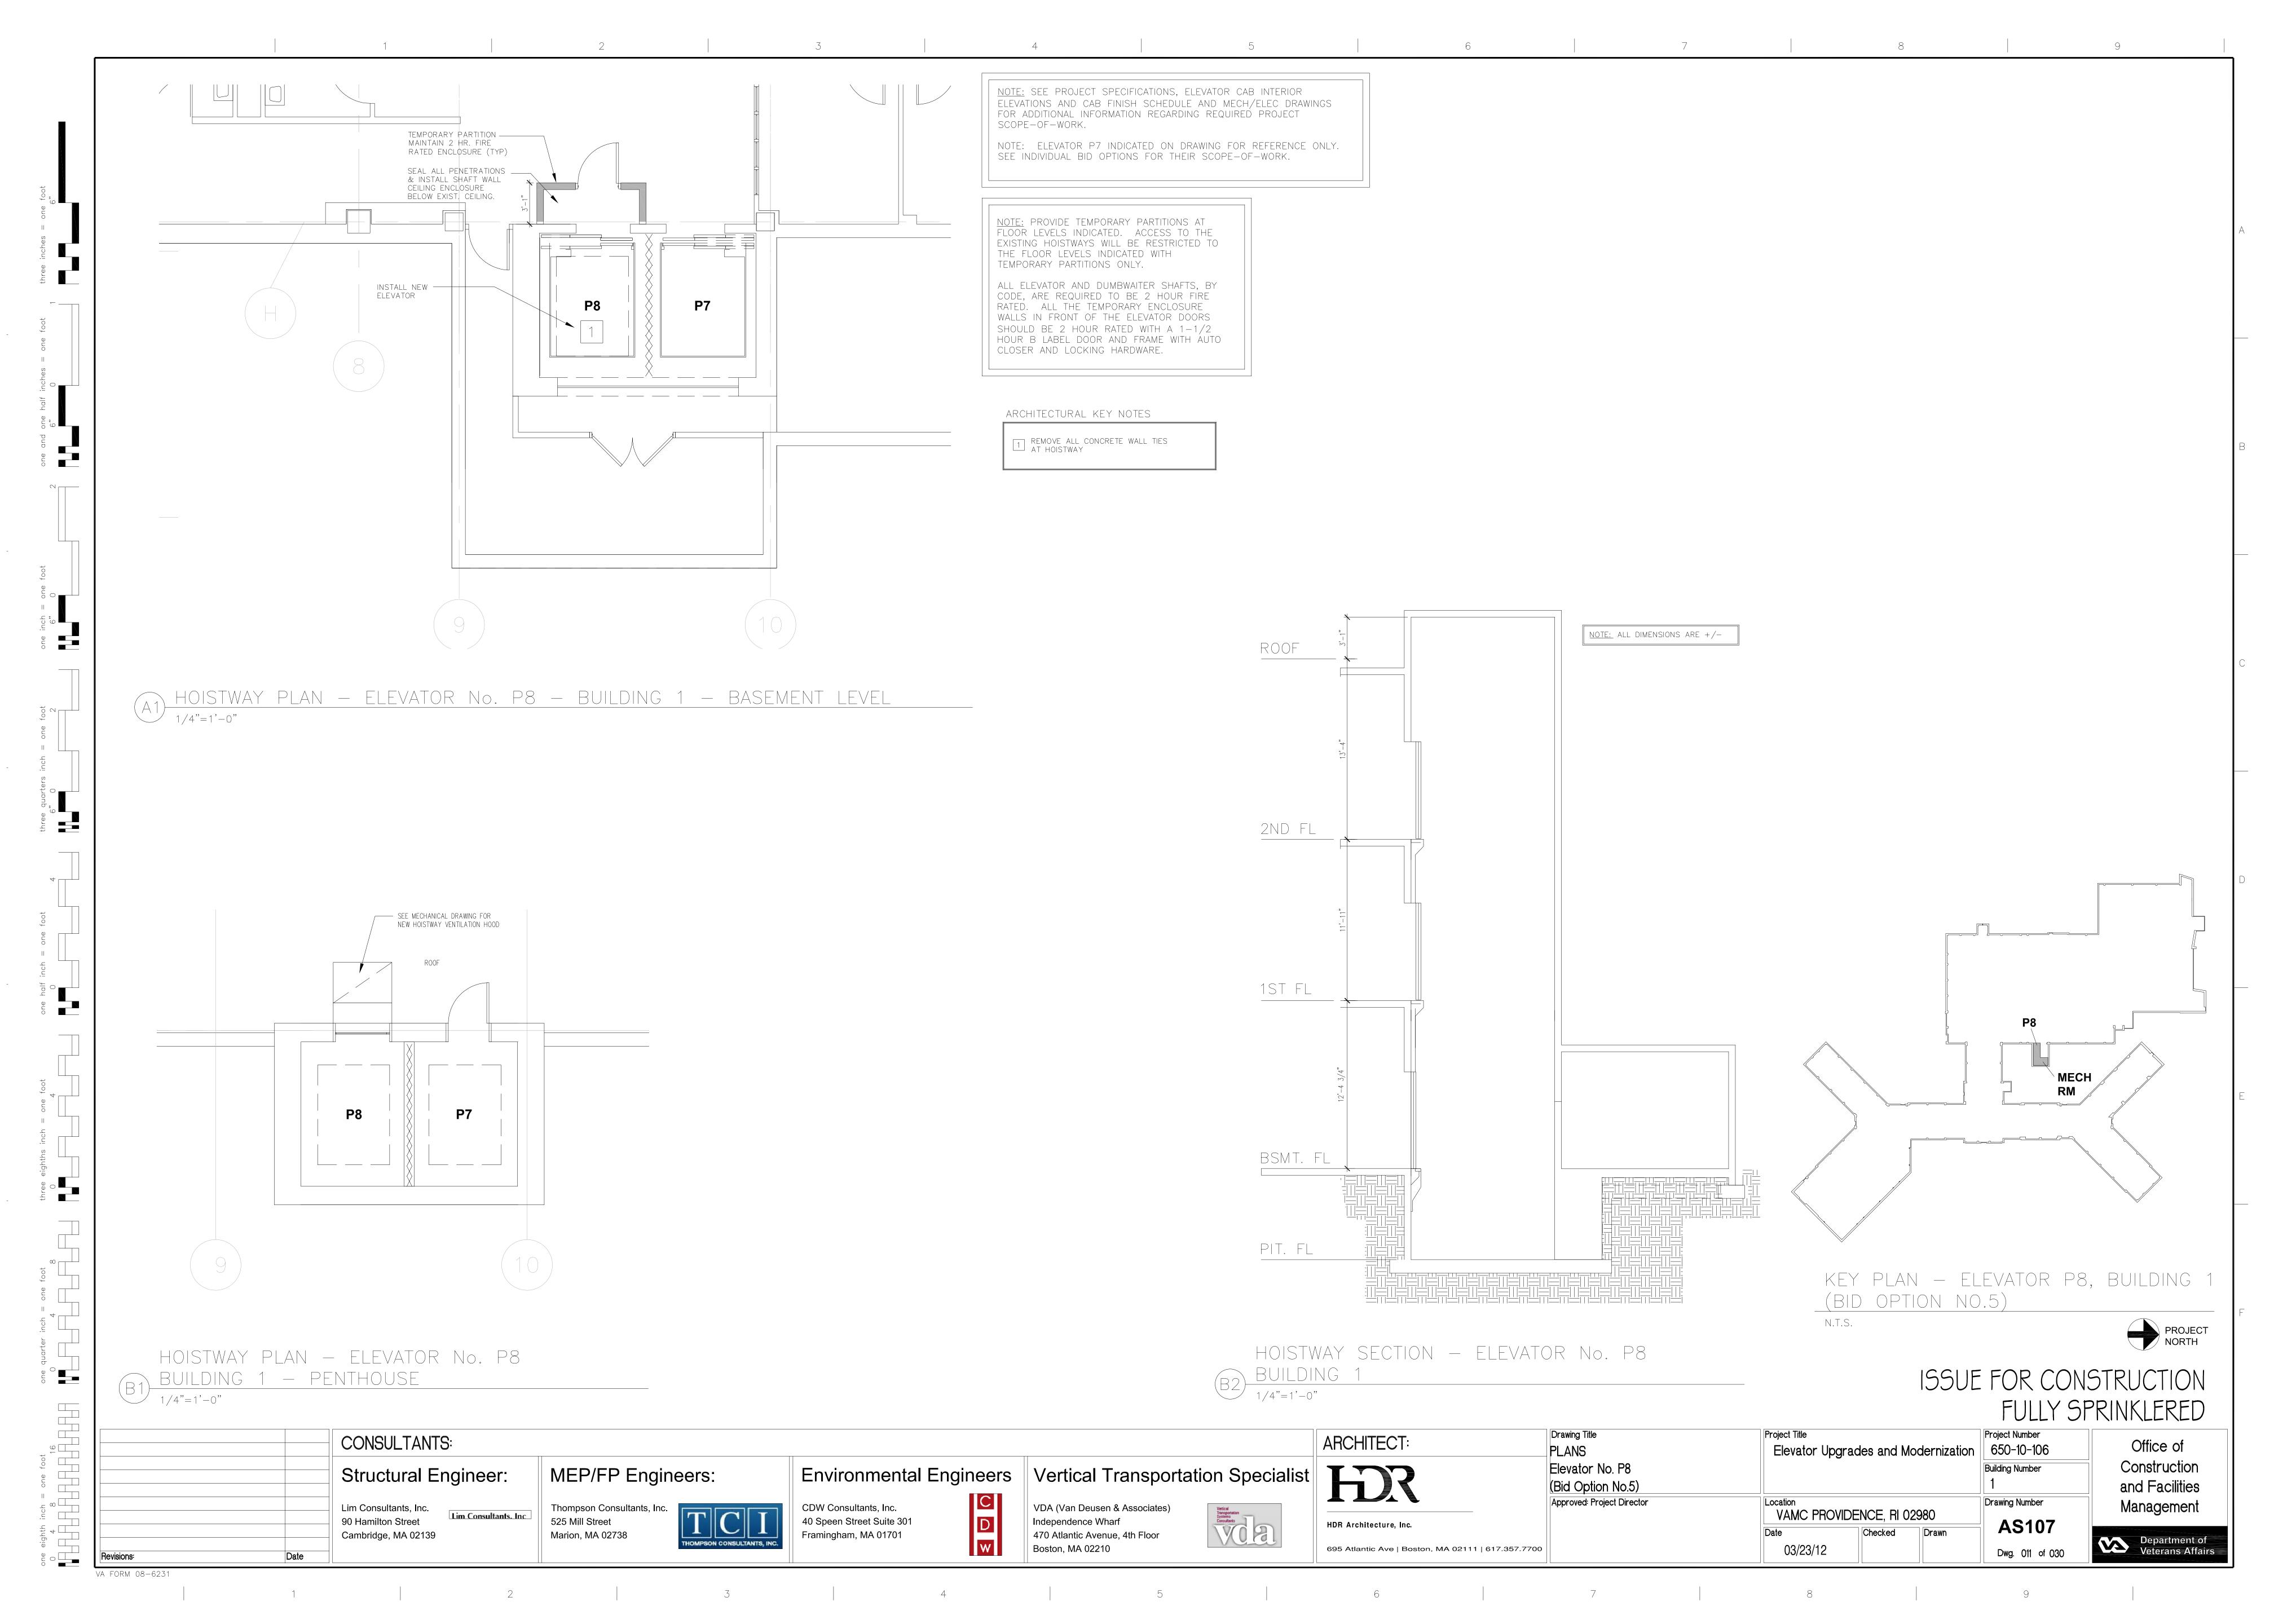


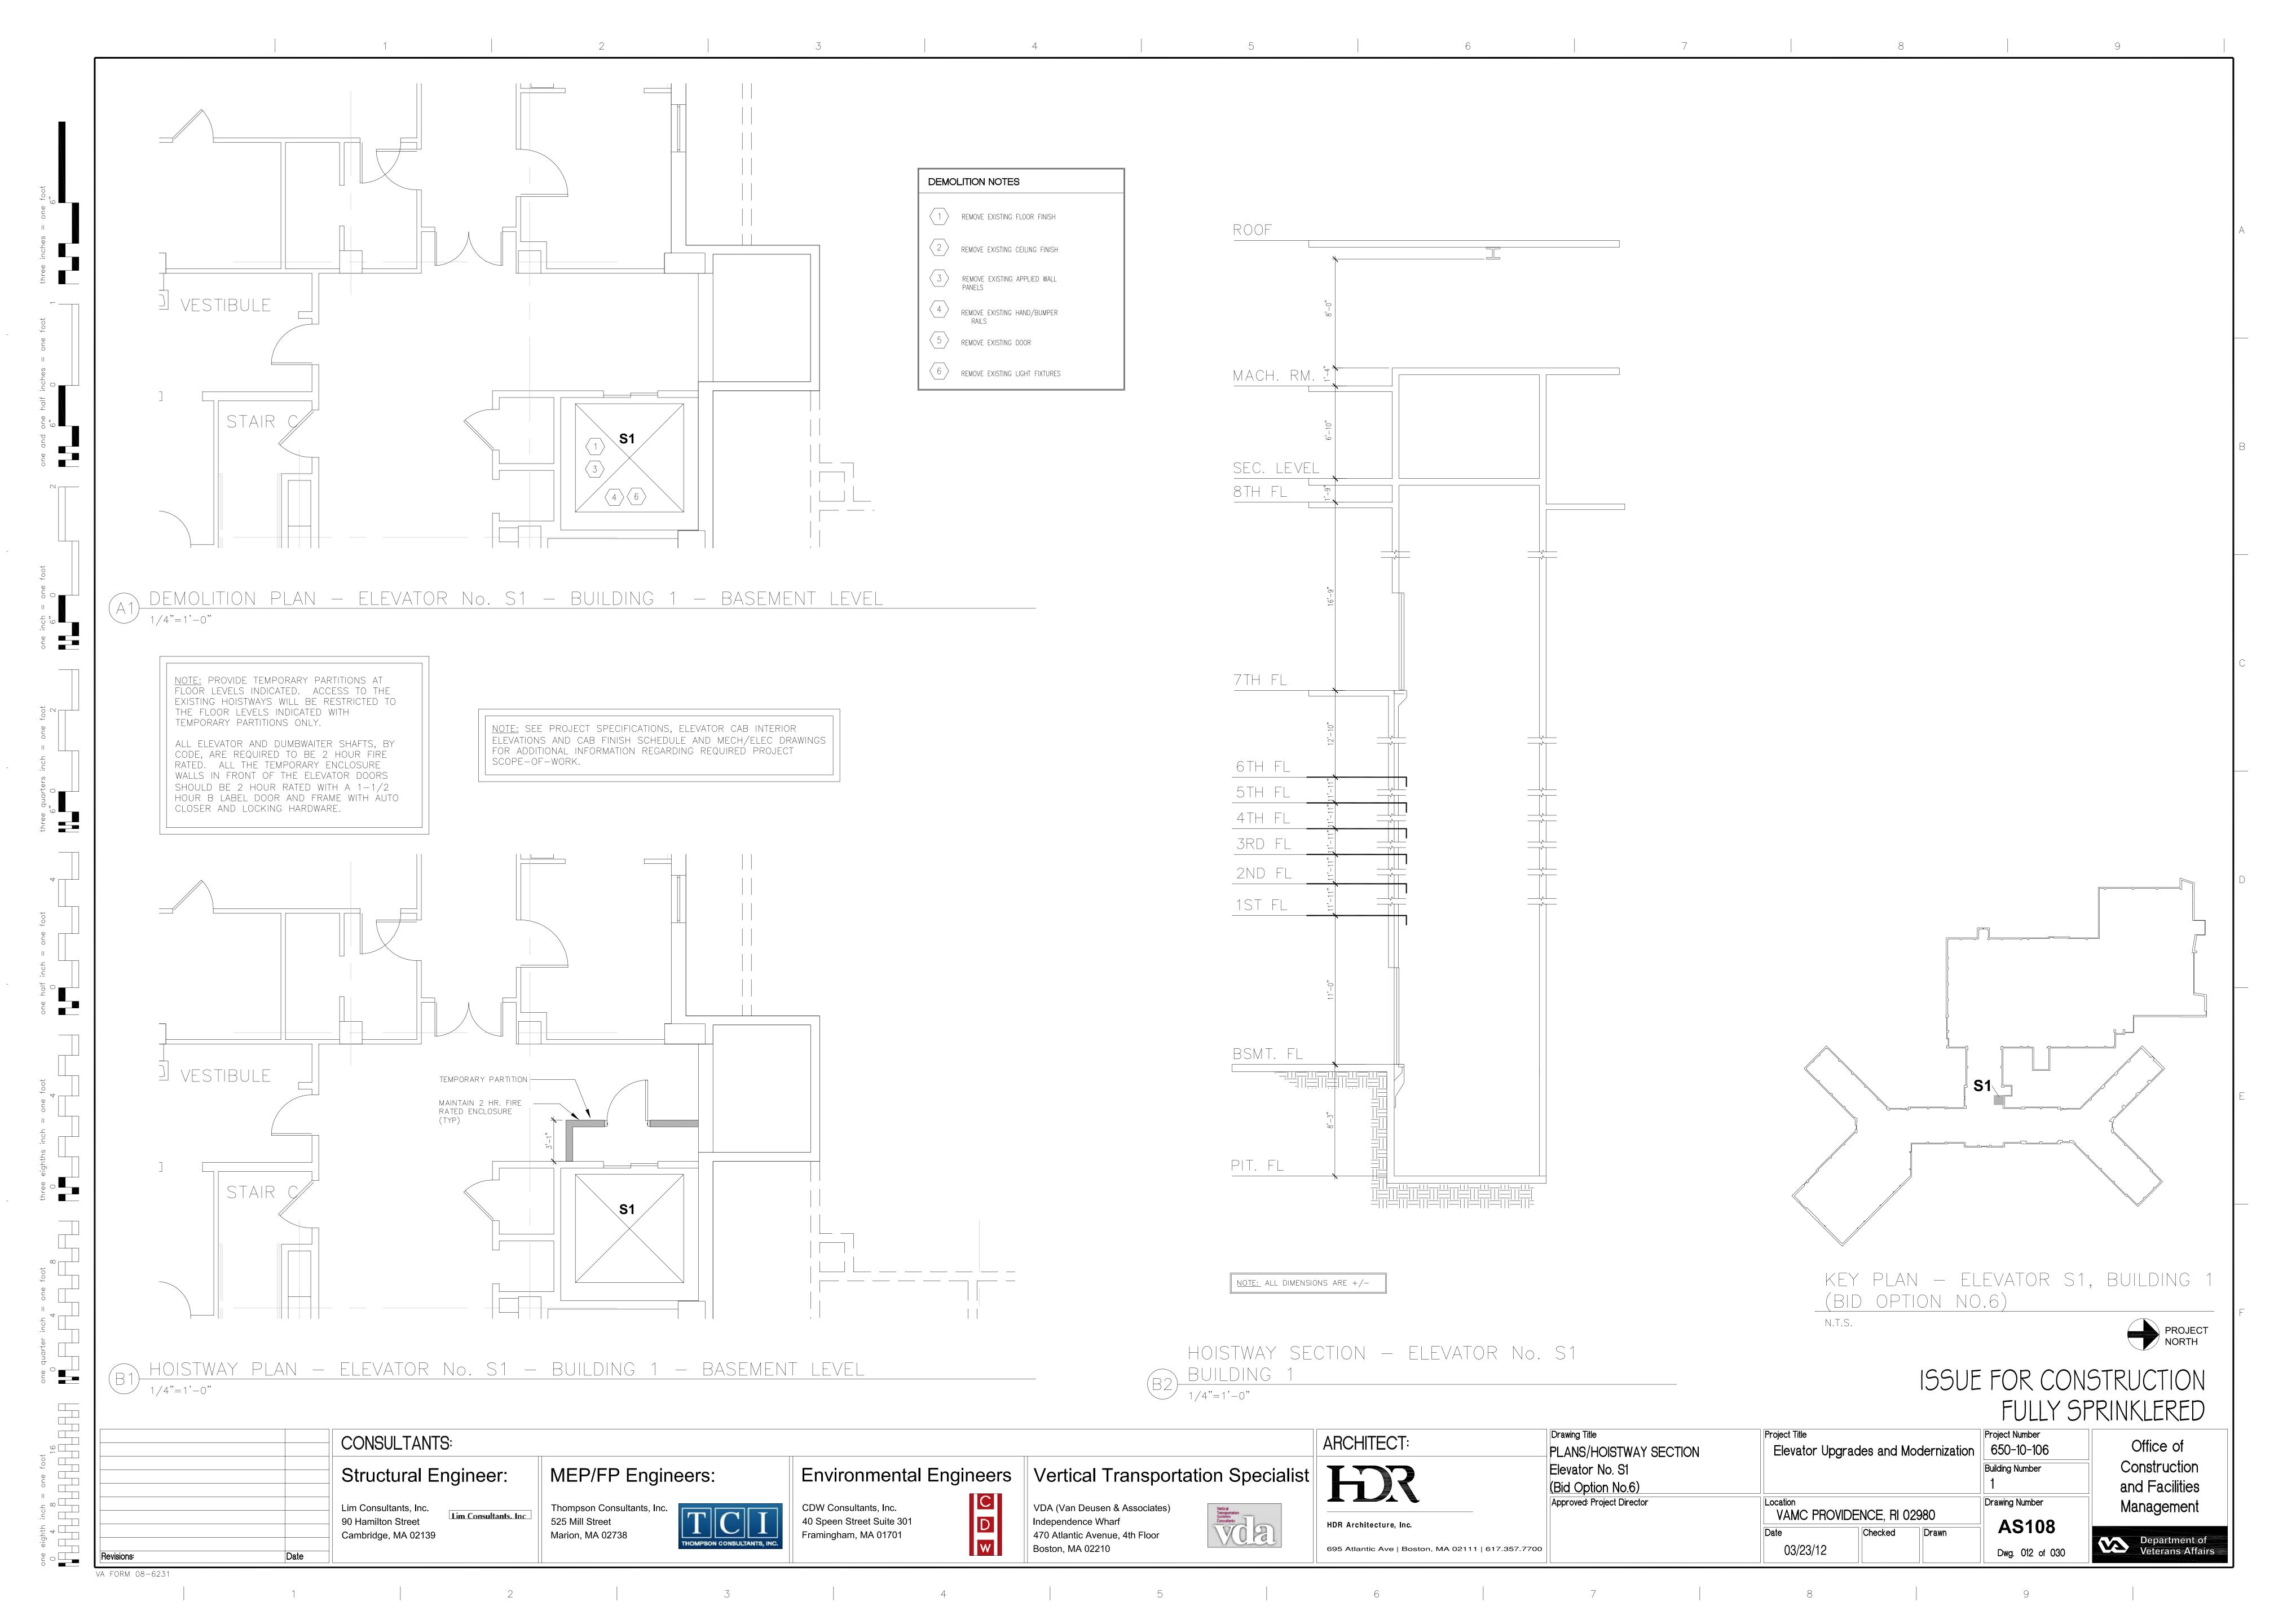

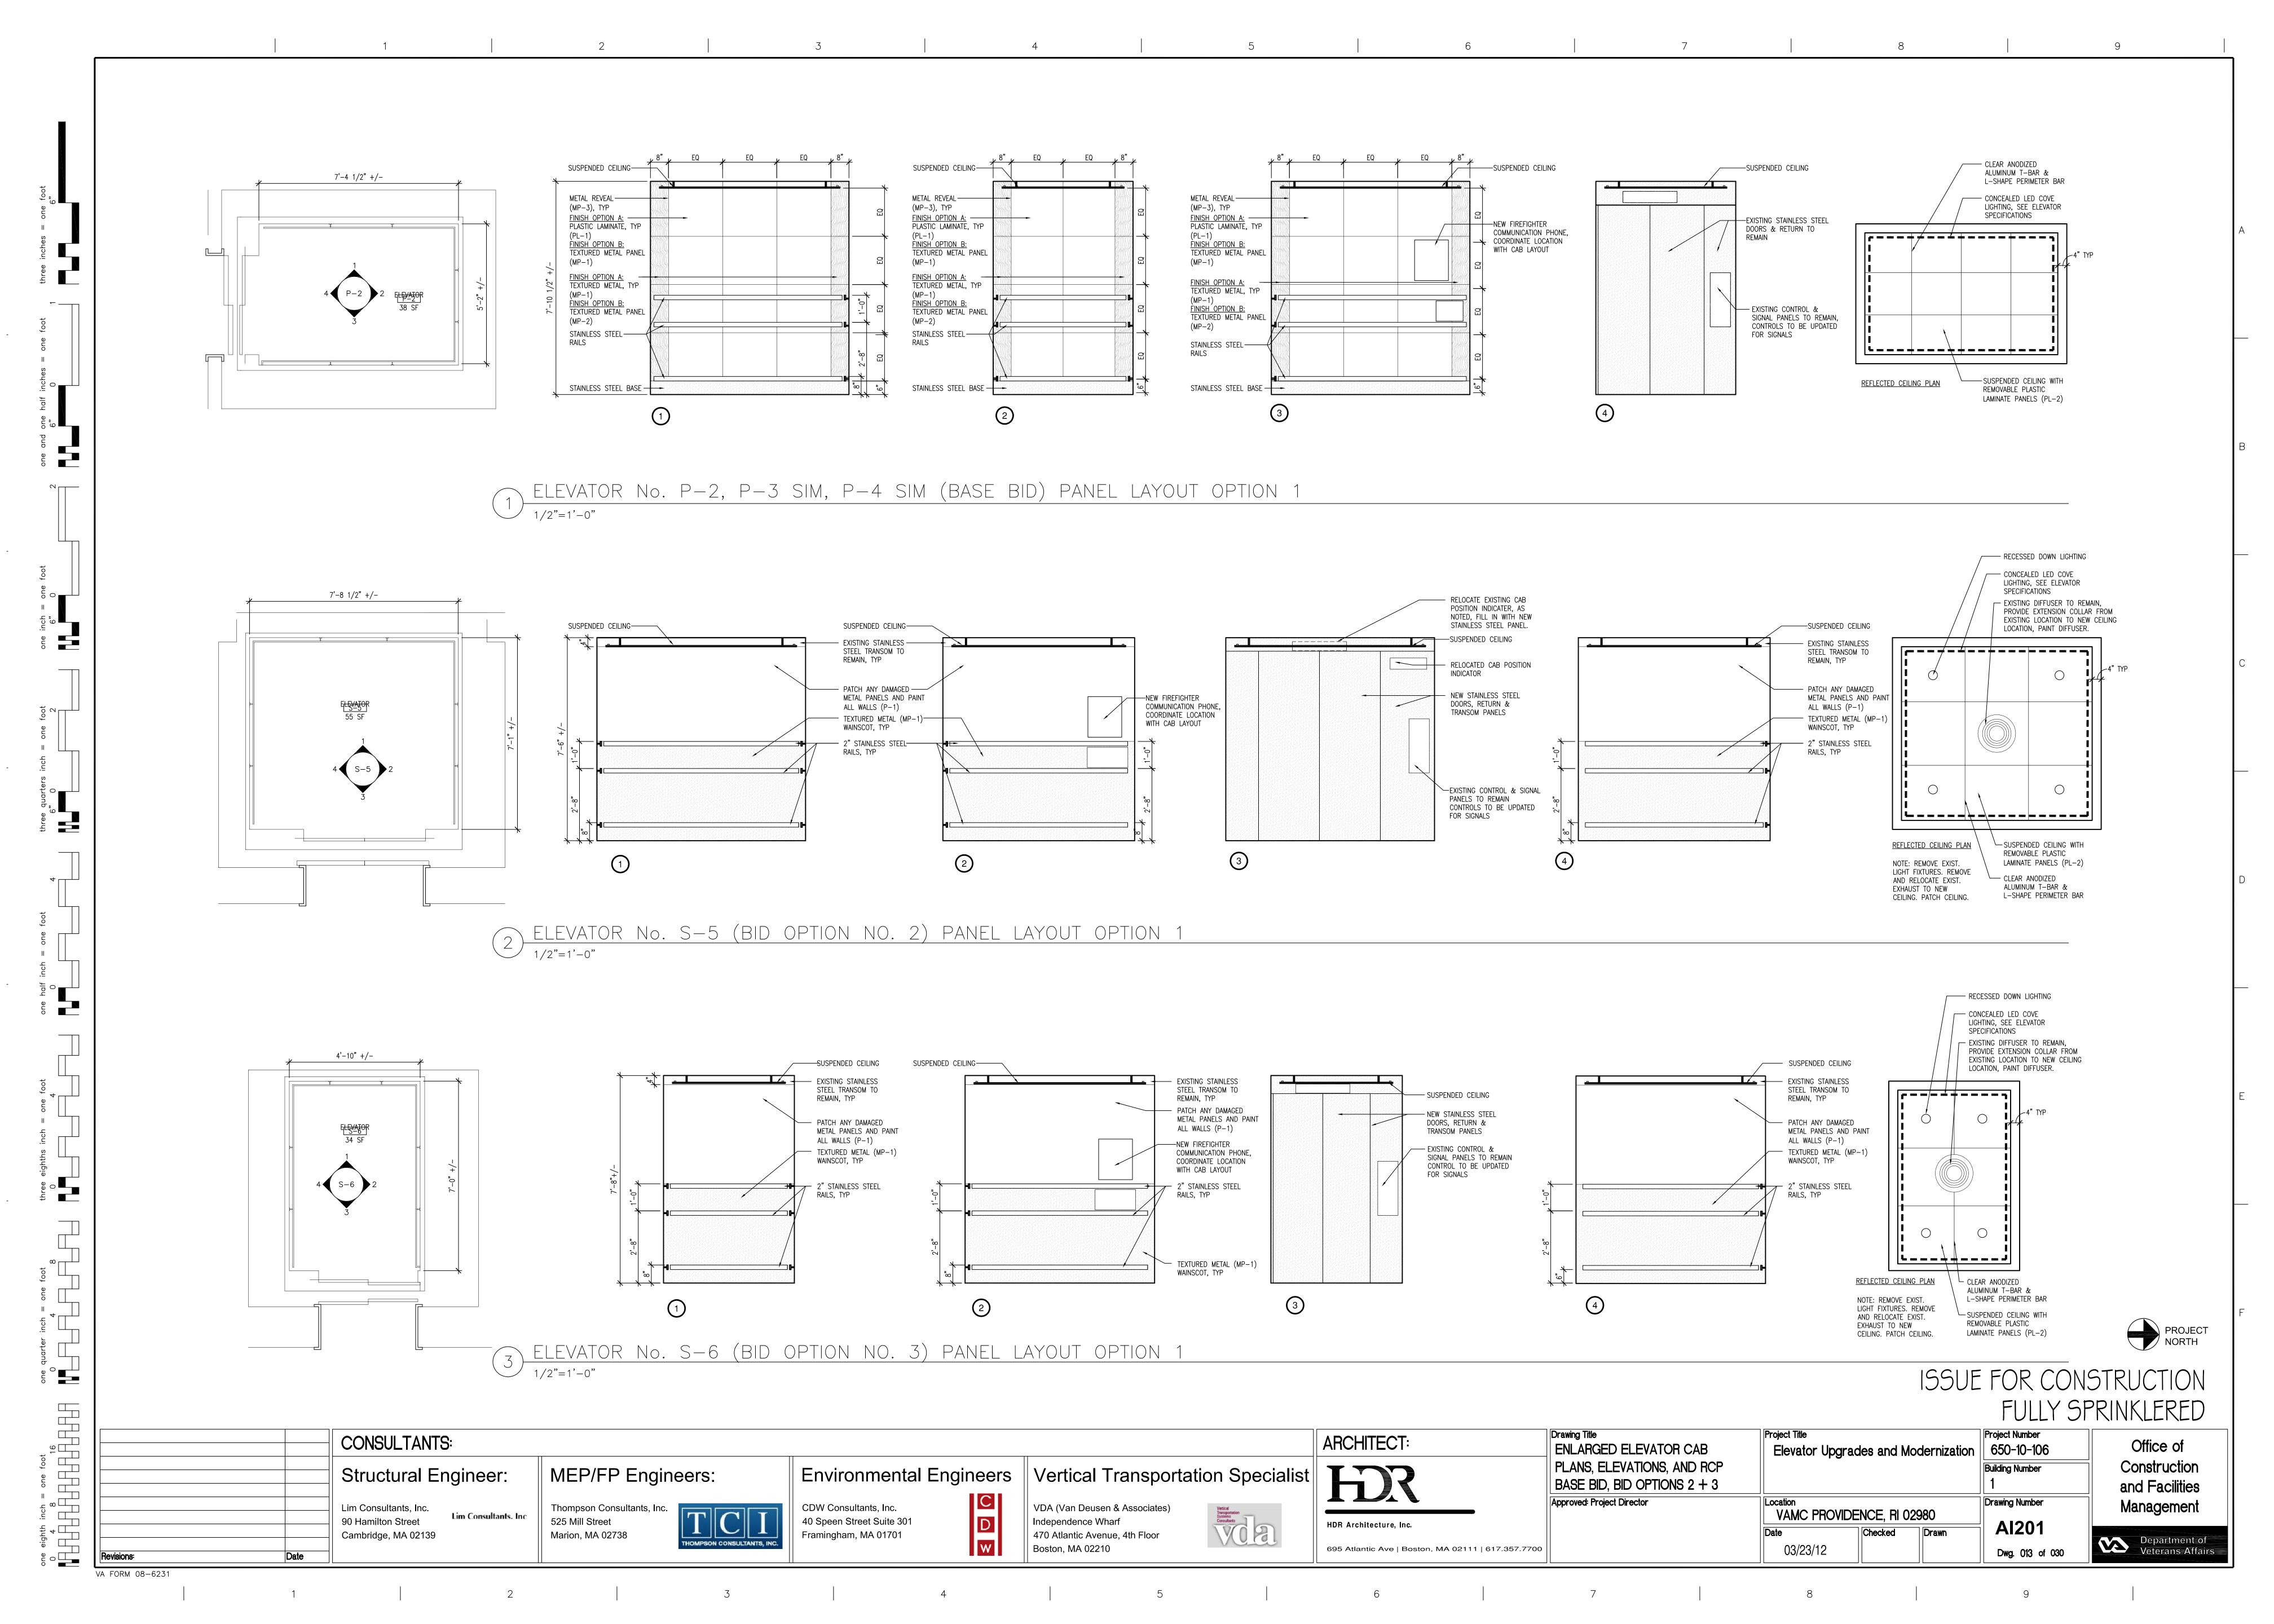

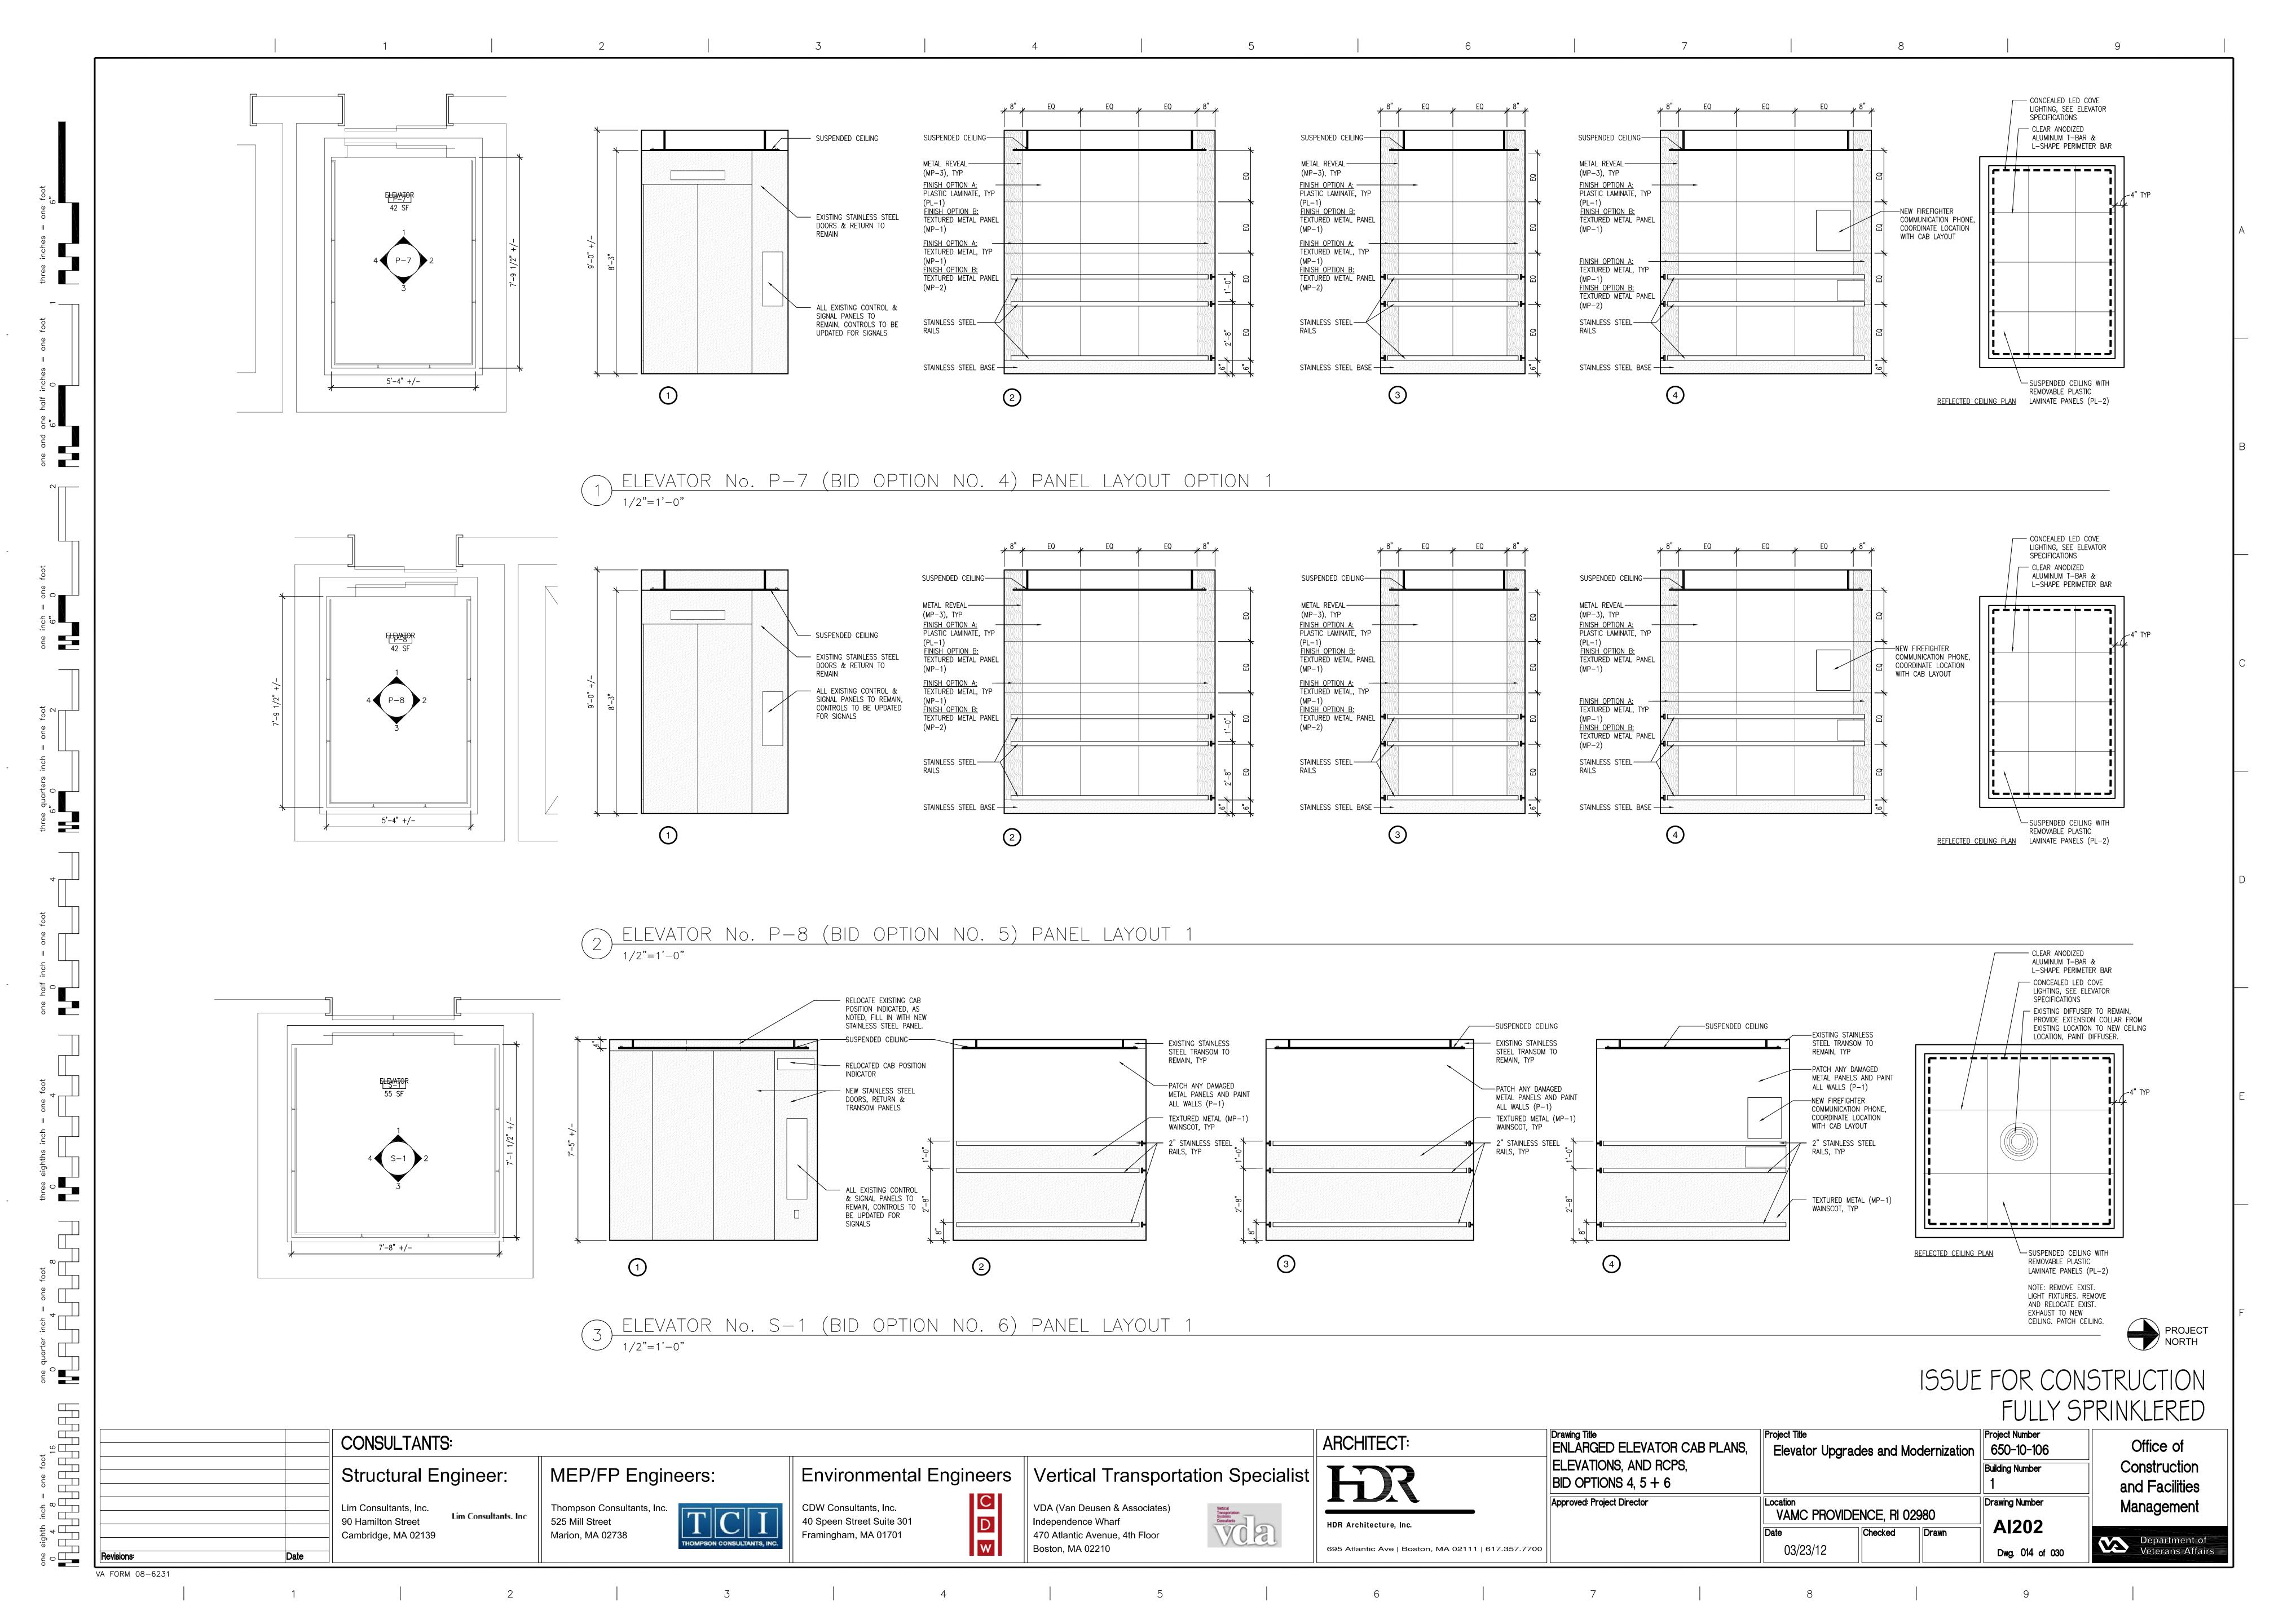

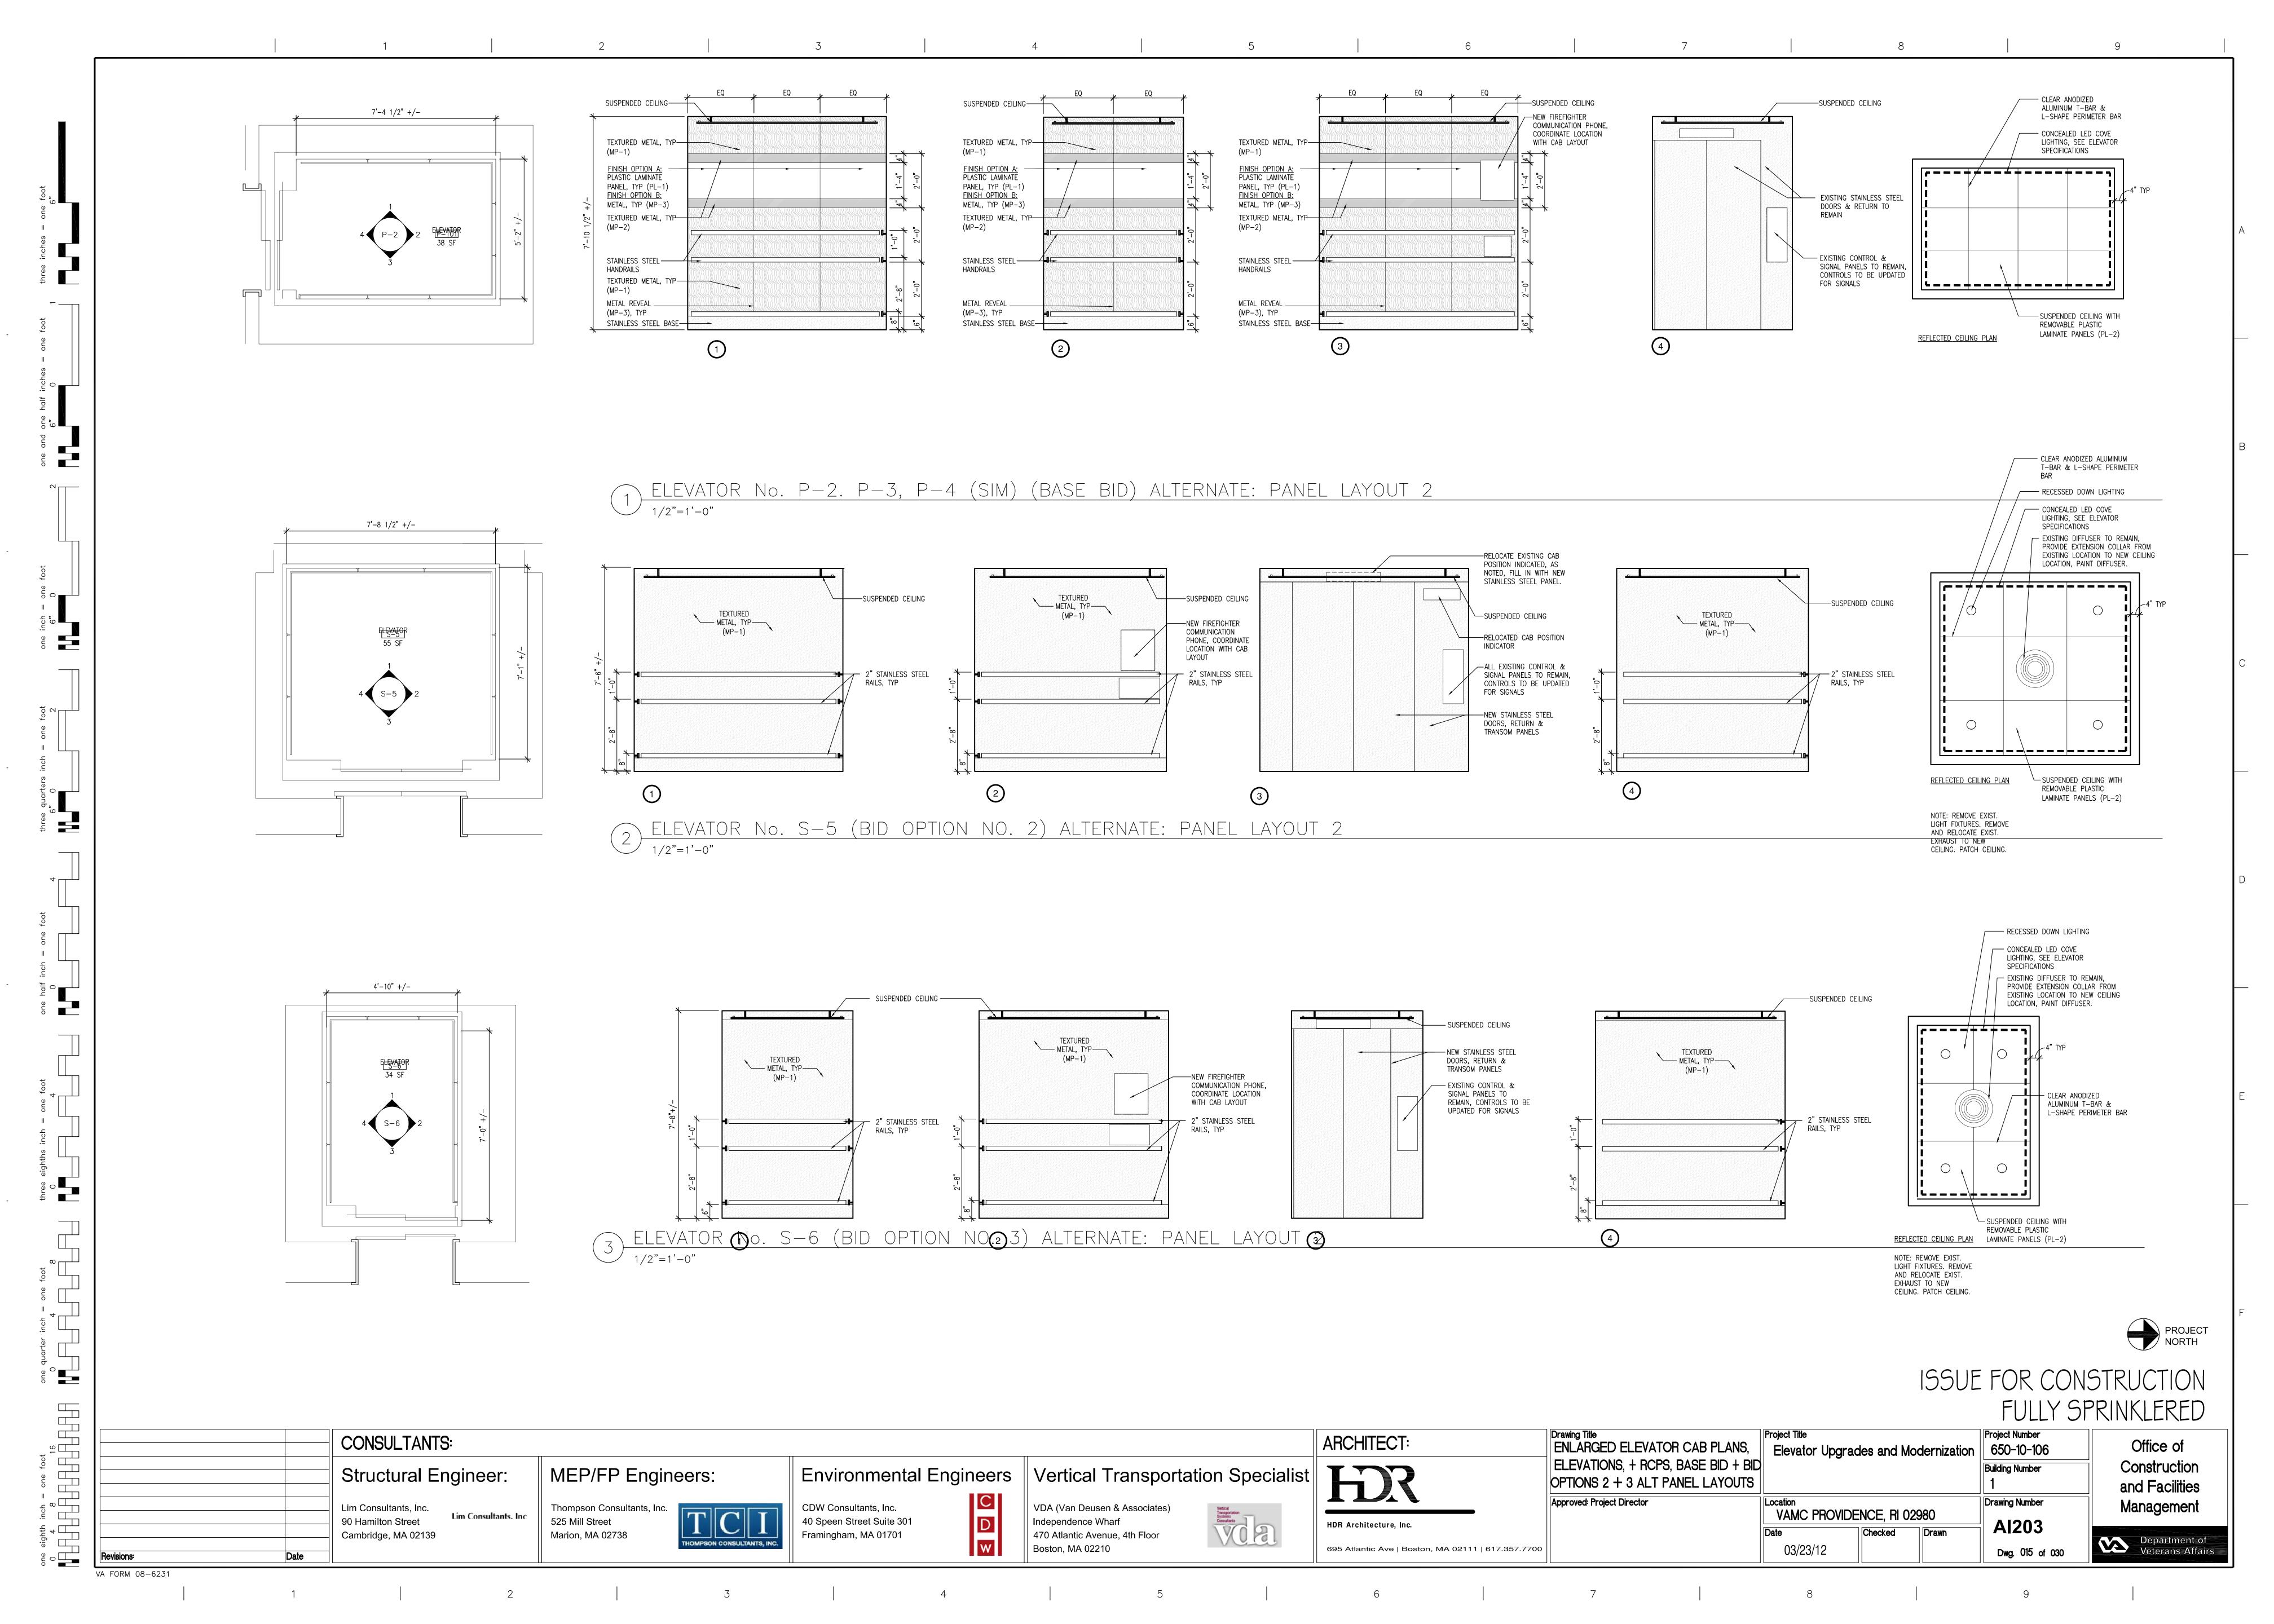

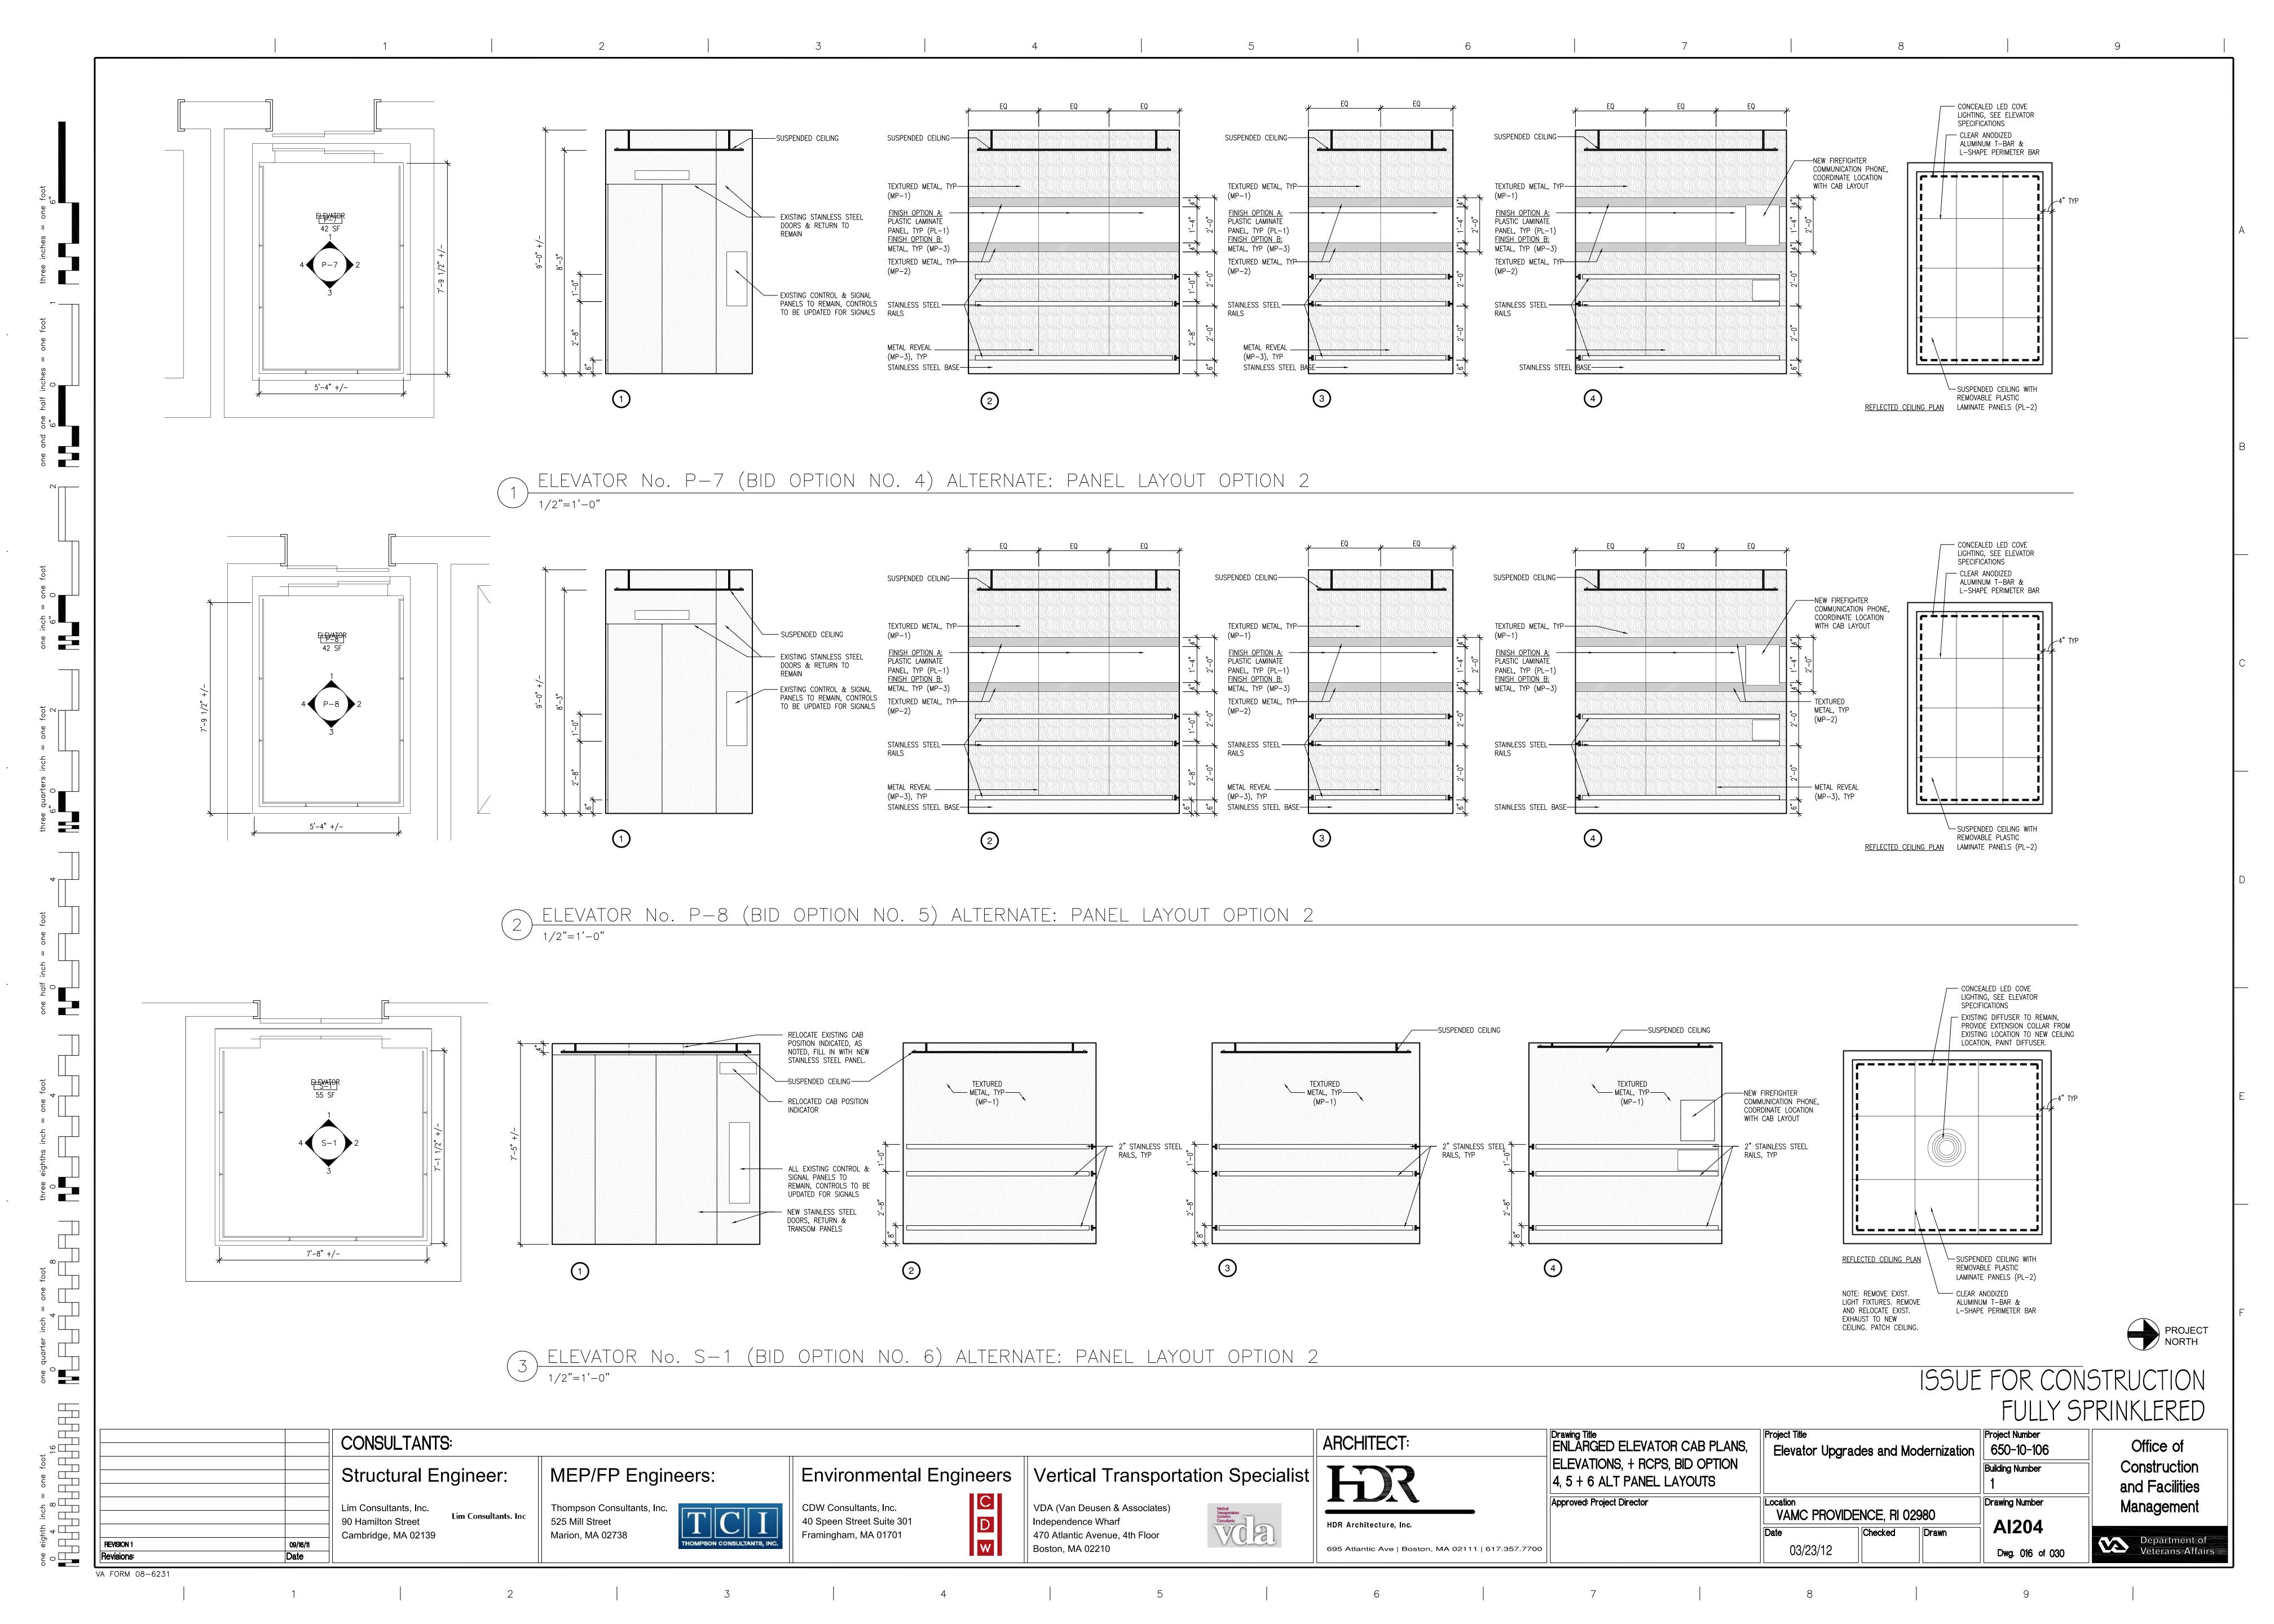

ELEVATOR CAB INTERIOR COLORS & MATERIAL FINISH SCHEDULE DECORATIVE METAL PANELS FLOORING COLOR: TO MATCH BENJAMIN MOORE STYLE: FIBER REINFORCED LAMINATE STYLE: TO MATCH RIGIDIZED METALS MANUF: TO MATCH ATMOSPHERE MANCHESTER TAN HC-81 COLOR: TO MATCH NEVAMAR CALUNA PATTERN 6.WL STYLE: STRUCTURE FINISH: EGGSHELL CHERRY WC2001T FINISH: STAINLESS STEEL COLOR: TM904 ELEMENTAL GREY USE: ALL ELEVATOR FLOORING, UNLESS USE: ALL CAB WALLS UNLESS USE: WALL PANELS AS NOTED NOTED. USE: PANELS AS NOTED OTHERWISE NOTED OTHERWISE NOTED

COLOR: TO MATCH BENJAMIN MOORE STYLE: TO MATCH PLASTIC LAMINATE STYLE: TO MATCH RIGIDIZED METALS PATTERN LINEN COLOR: SW803 SUEDE EGGSHELL FINISH: STAINLESS STEEL ALL EXISTING DIFFUSERS WITHIN WHITE USE: PANELS AS NOTED ELEV. CAB TO BE PAINTED, AS USE: ALL CEILING PANELS UNLESS OTHERWISE NOTED NOTED.

STYLE: 2" STAINLESS STEEL RAILS FINISH: NO. 4 USE: ALL RAILS UNLESS OTHERWISE NOTED.

STYLE: STAINLESS STEEL FINISH: NO. 4 USE: PANELS AS NOTED, AND ALL NEW ELEVATOR DOORS AND RETURNS, UNLESS OTHERWISE NOTED.

ELEVATOR CAB FINISH SCHEDULE

ROOM FINISH SCHEDULE											
ROOM NUMBER	ROOM NAME	FLOOR	BASE	WAINSCOT	WALL W/ DOOR OPENING	WALLS (ALL OTHER)	OTHER) CEILING MATERIAL HEIGH		NOTES		
S-1	ELEVATOR	Rubber	N/A	MTL	SS DOOR AND RETURN	PNT	PNT	7'-4"	SEE COLOR & MATERIAL SCHEDULE & INT ELEVATIONS FOR ADDITIONAL FINISH INFORMATION		
P-2	ELEVATOR	RUBBER	SS BASE	N/A	ETR	PL & MP	PL	7'-6"	SEE COLOR & MATERIAL SCHEDULE & INT ELEVATIONS FOR ADDITIONAL FINISH INFORMATION		
P-3	ELEVATOR	RUBBER	SS BASE	N/A	ETR	PL & MP	PL	7'-6"	SEE COLOR & MATERIAL SCHEDULE & INT ELEVATIONS FOR ADDITIONAL FINISH INFORMATION		
P-4	ELEVATOR	RUBBER	SS BASE	N/A	ETR	PL & MP	PL	7'-6"	SEE COLOR & MATERIAL SCHEDULE & INT ELEVATIONS FOR ADDITIONAL FINISH INFORMATION		
S-5	ELEVATOR	RUBBER	N/A	MTL	SS DOOR AND RETURN	PNT	PNT	7'-4"	SEE COLOR & MATERIAL SCHEDULE & INT ELEVATIONS FOR ADDITIONAL FINISH INFORMATION		
S-6	ELEVATOR	RUBBER	N/A	MTL	SS DOOR AND RETURN	PNT	PNT	7'-8"	SEE COLOR & MATERIAL SCHEDULE & INT ELEVATIONS FOR ADDITIONAL FINISH INFORMATION		
P-7	ELEVATOR	RUBBER	SS BASE	N/A	ETR	PL & MP	PL	8'-3"	SEE COLOR & MATERIAL SCHEDULE & INT ELEVATIONS FOR ADDITIONAL FINISH INFORMATION		
P-8	ELEVATOR	RUBBER	SS BASE	N/A	SS DOOR AND RETURN	PL & MP	PL	8'-3"	SEE COLOR & MATERIAL SCHEDULE & INT ELEVATIONS FOR ADDITIONAL FINISH INFORMATION		
						<u> </u>					

#### GENERAL COLORS & MATERIAL FINISH SCHEDULE

PNT-3

PNT-4 COLOR: TO MATCH BENJAMIN MOORE COLOR: TO MATCH BENJAMIN MOORE CHANTILLY LACE 2121-70 FINISH: SEMI-GLOSS FINISH: EGGSHELL USE: ALL WALLS AND TEMPORARY USE: ALL HM DOORS AND FRAMES, PARTITIONS UNLESS OTHERWISE NOTED UNLESS NOTED OTHERWISE.

#### **FINISH NOTES**

- 1. ANY SURFACES AND AREAS THAT ARE DISTURBED BY CONSTRUCTION ARE TO BE PATCHED AND MATCHED TO EXISTING FINISHES.
- 2. ALL ELEVATOR DOORS AND LOBBY AREA WALLS ARE TO REMAIN, UNLESS OTHERWISE NOTED.
- 3. ALL ELEVATOR CABS SHOULD BE PROVIDED WITH HOOKS FOR REMOVABLE PADS.


A1 FINISH INFORMATION NTS

DOOR SCHEDULE

BOOK CONEBCE								
DOOR #	LOCATION	BASE BID/ BID OPTION No.	SIZE	DOOR TYPE	FRAME TYPE	NOTES		
B101	S6 MACHINE ROOM	BID OPTION 3	3'-0" X 7'-0"	A	1	DEMOLISH EXISTING DOOR & REPLACE WITH CODE COMPLIANT DOOR, LABEL PER CODE		
B107	P7/P8 MACHINE RM	BID OPTION 4&5	ETR	ETR	ETR	REMOVE PAINT FROM HM DOOR FRAME REPLACE HARDWARE WITH LEVER LOCKSET		
B108	P7/P8 MACHINE RM	BID OPTION 4&5	ETR	ETR OR A SEE NOTE	ETR OR 1 SEE NOTE	REPLACE DOOR AND FRAME OR CONFIRM 2 HOUR FIRE RATING OF EXISTING		
501	S5 MACHINE ROOM	BID OPTION 2	ETR	ETR	ETR	INSTALL SIGNAGE ON DOOR "ELEVATOR MACHINE ROOM NO STORAGE ALLOWED" REPLACE HARDWARE WITH LEVER LOCKSET		
901	STAIR C	BASE BID	ETR	ETR	ETR	INSTALL SIGNAGE ON DOOR "ELEVATOR MACHINE ROOM NO STORAGE ALLOWED" REPLACE HARDWARE WITH LEVER LOCKSET		

NOTE: ALL DOORS TO BE 90 MIN RATED WITH LOCKING HARDWARE, DOOR CLOSER AND STAINLESS STEEL KICKPLATE.

A2 DOOR SCHEDULES NTS

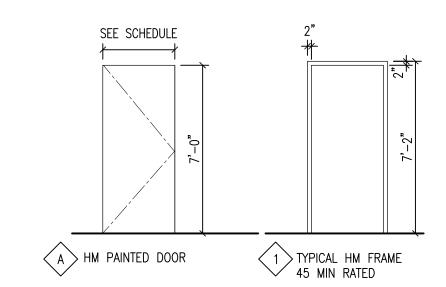

# ISSUE FOR CONSTRUCTION FULLY SPRINKLERED

		CONSULTANT
		Structural E
		Lim Consultants, Inc. 90 Hamilton Street Cambridge, MA 02139
Revisions:	Date	Cambridge, MA 02 109

CONSULTANTS: MEP/FP Engineers: Structural Engineer:

Thompson Consultants, Inc. Lim Consultants. Inc 525 Mill Street Marion, MA 02738

CDW Consultants, Inc. 40 Speen Street Suite 301 Framingham, MA 01701

C D w

Environmental Engineers | Vertical Transportation Specialist VDA (Van Deusen & Associates) Independence Wharf 470 Atlantic Avenue, 4th Floor Boston, MA 02210

HDR Architecture, Inc. 695 Atlantic Ave | Boston, MA 02111 | 617.357.7700

ARCHITECT:

Drawing Title
DOOR AND FINISH SCHEDULE, FINISH LEGEND AND NOTES Approved: Project Director


Project Title Project Number 650-10-106 Elevator Upgrades and Modernization Building Number Drawing Number VAMC PROVIDENCE, RI 02980 **AI601** Checked


Office of Construction and Facilities Management Department of Veterans Affairs


03/23/12 Dwg. 017 of 030


one eighth inch = one foot


0 4 8 16

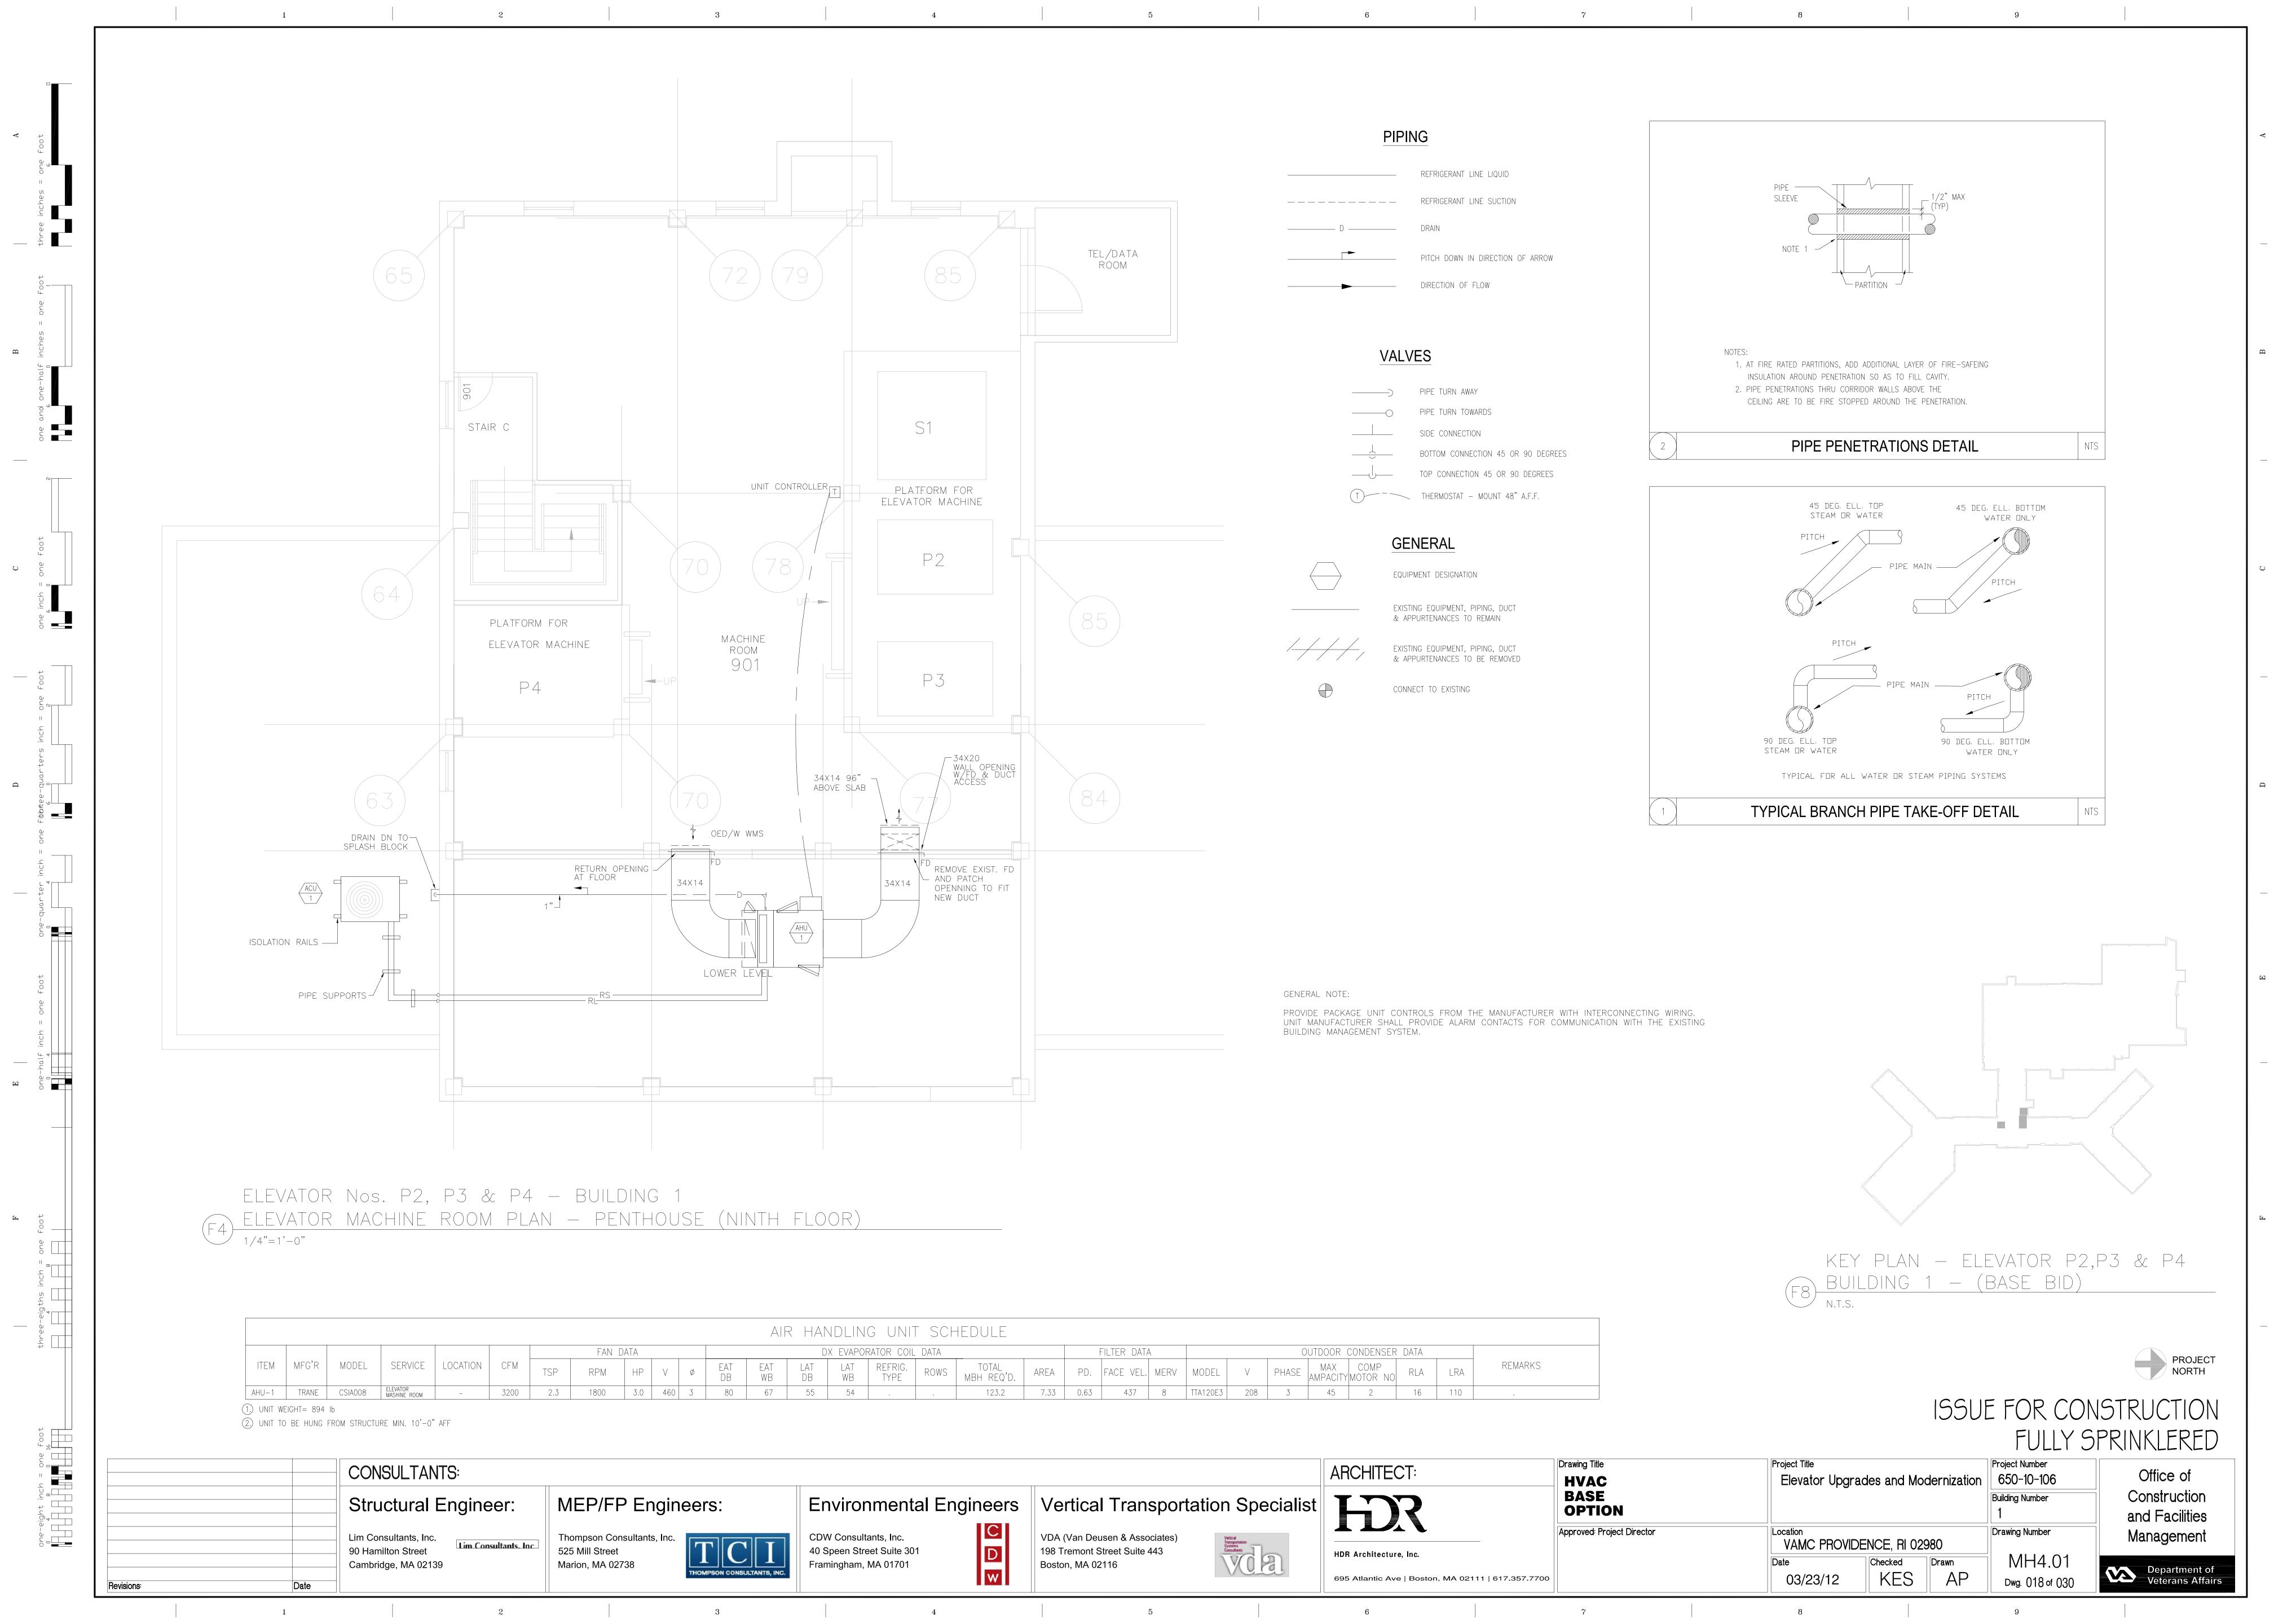


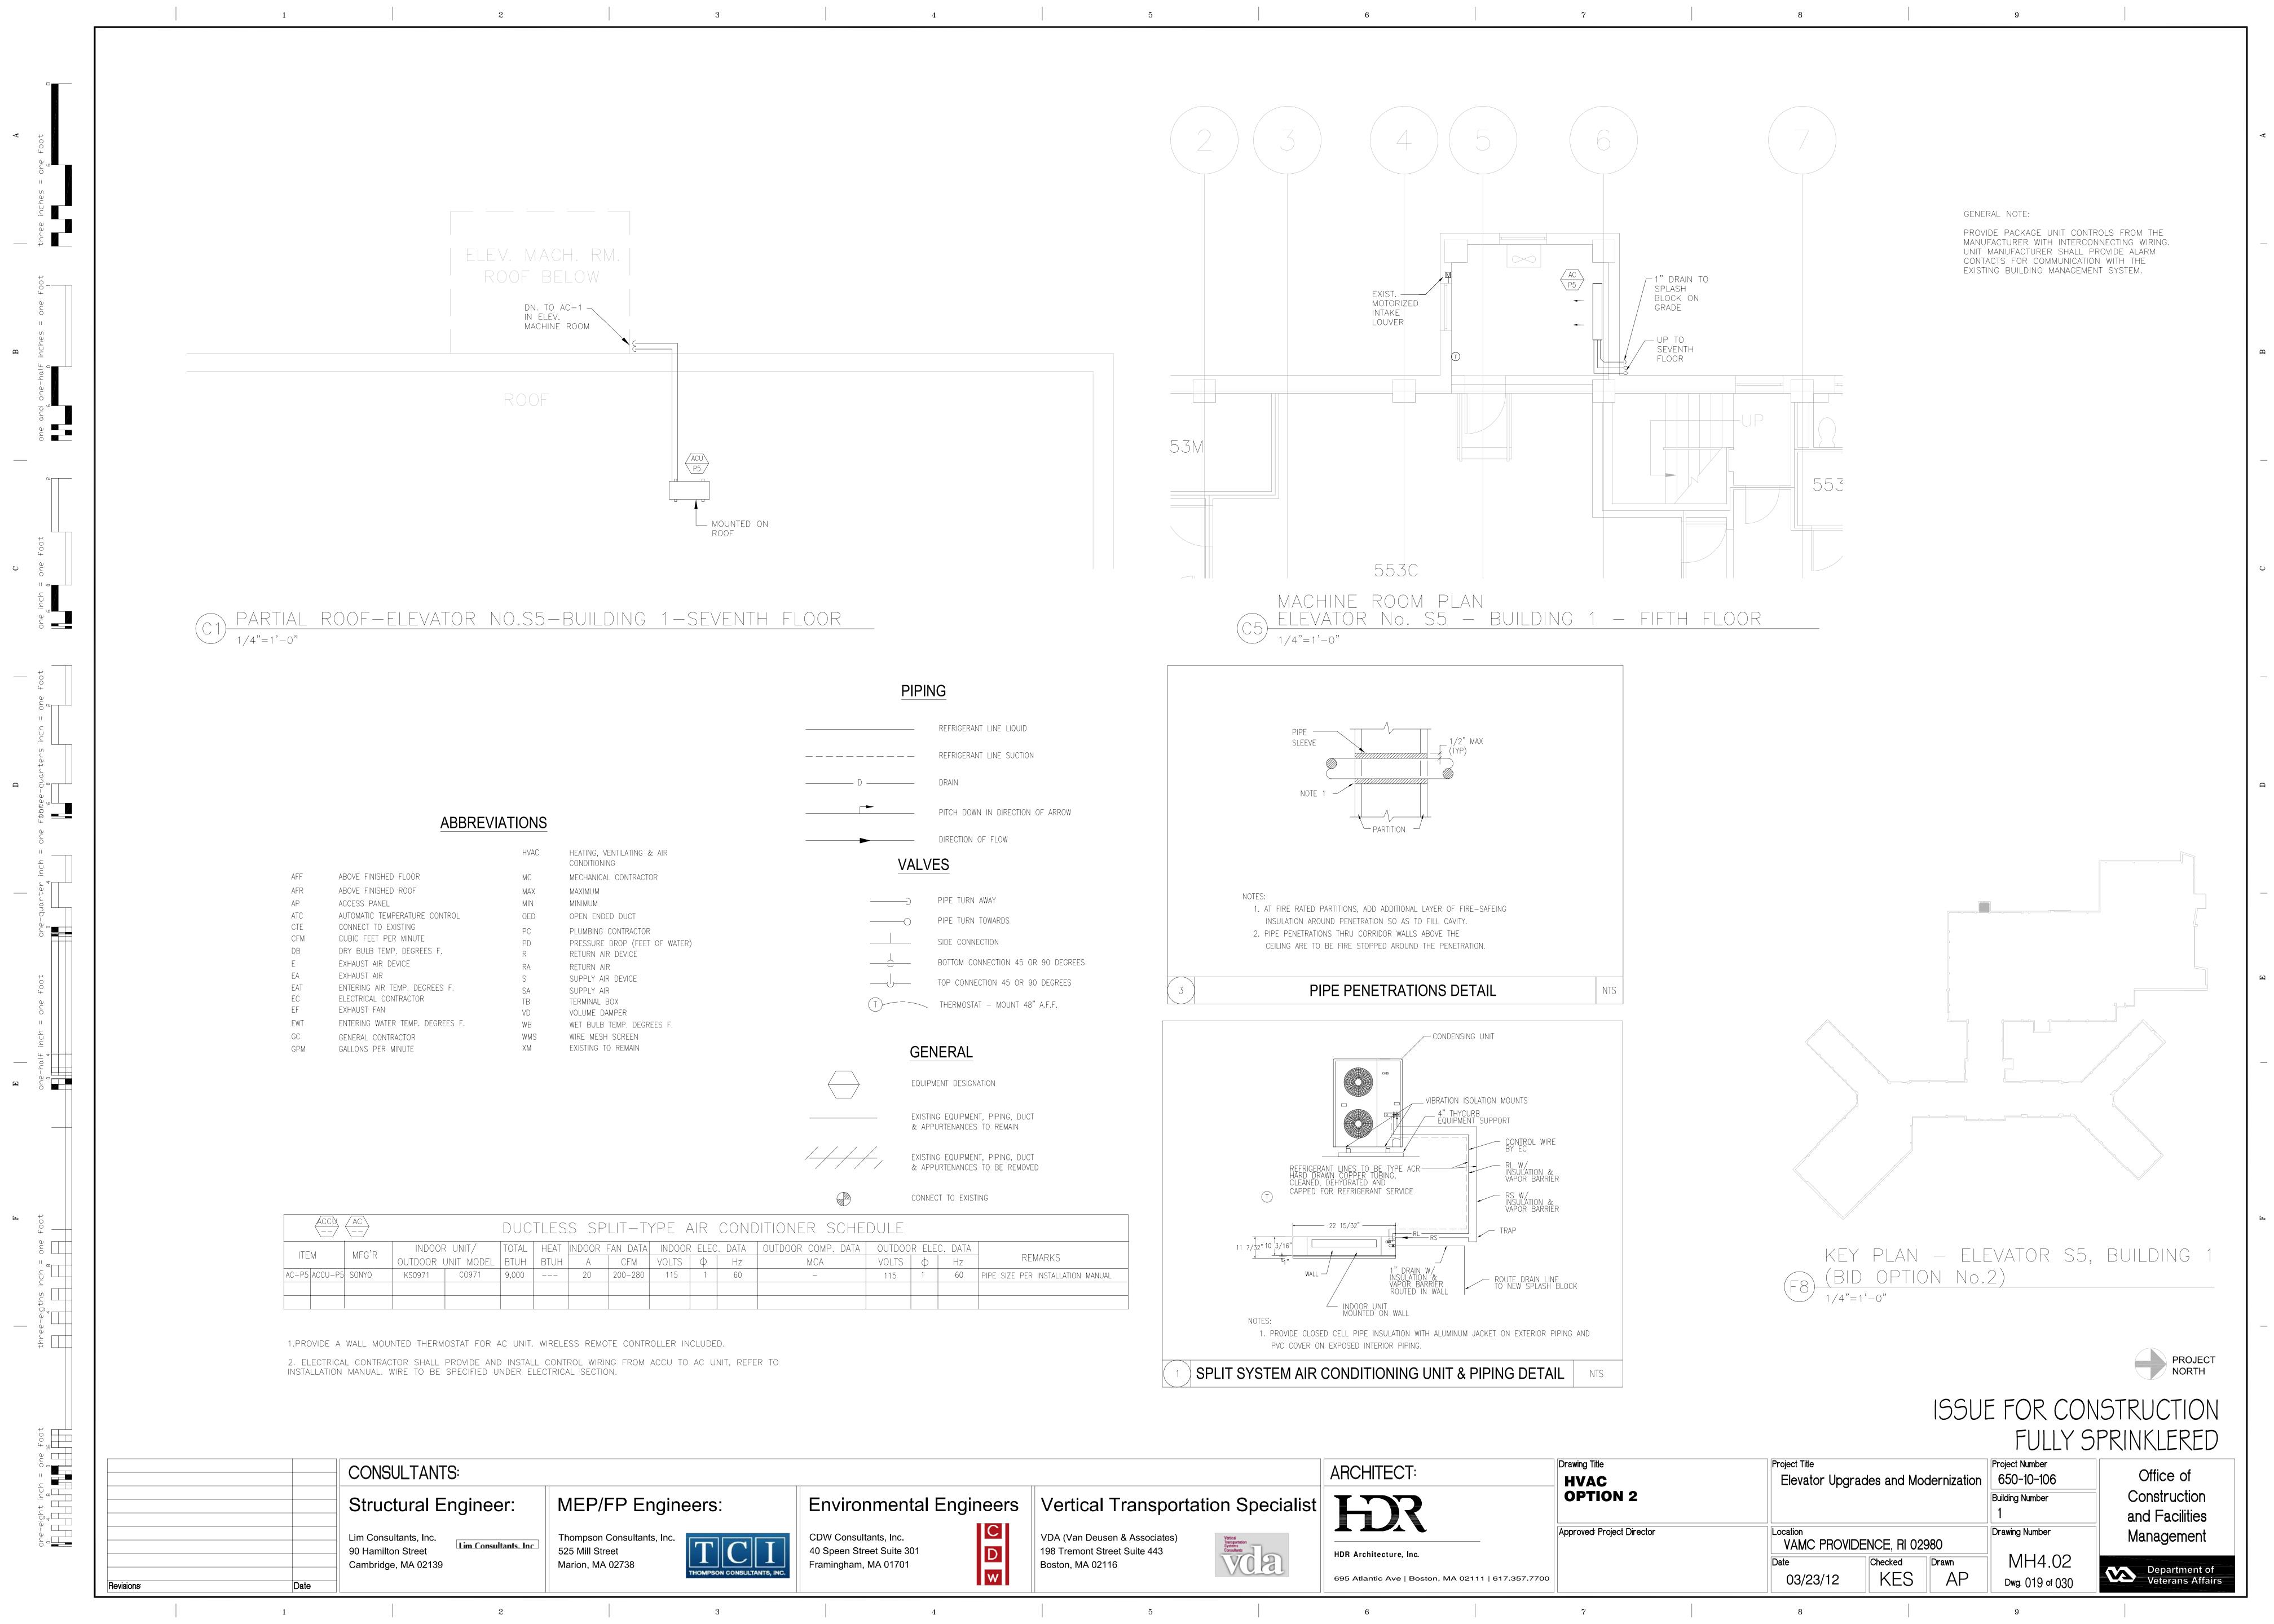

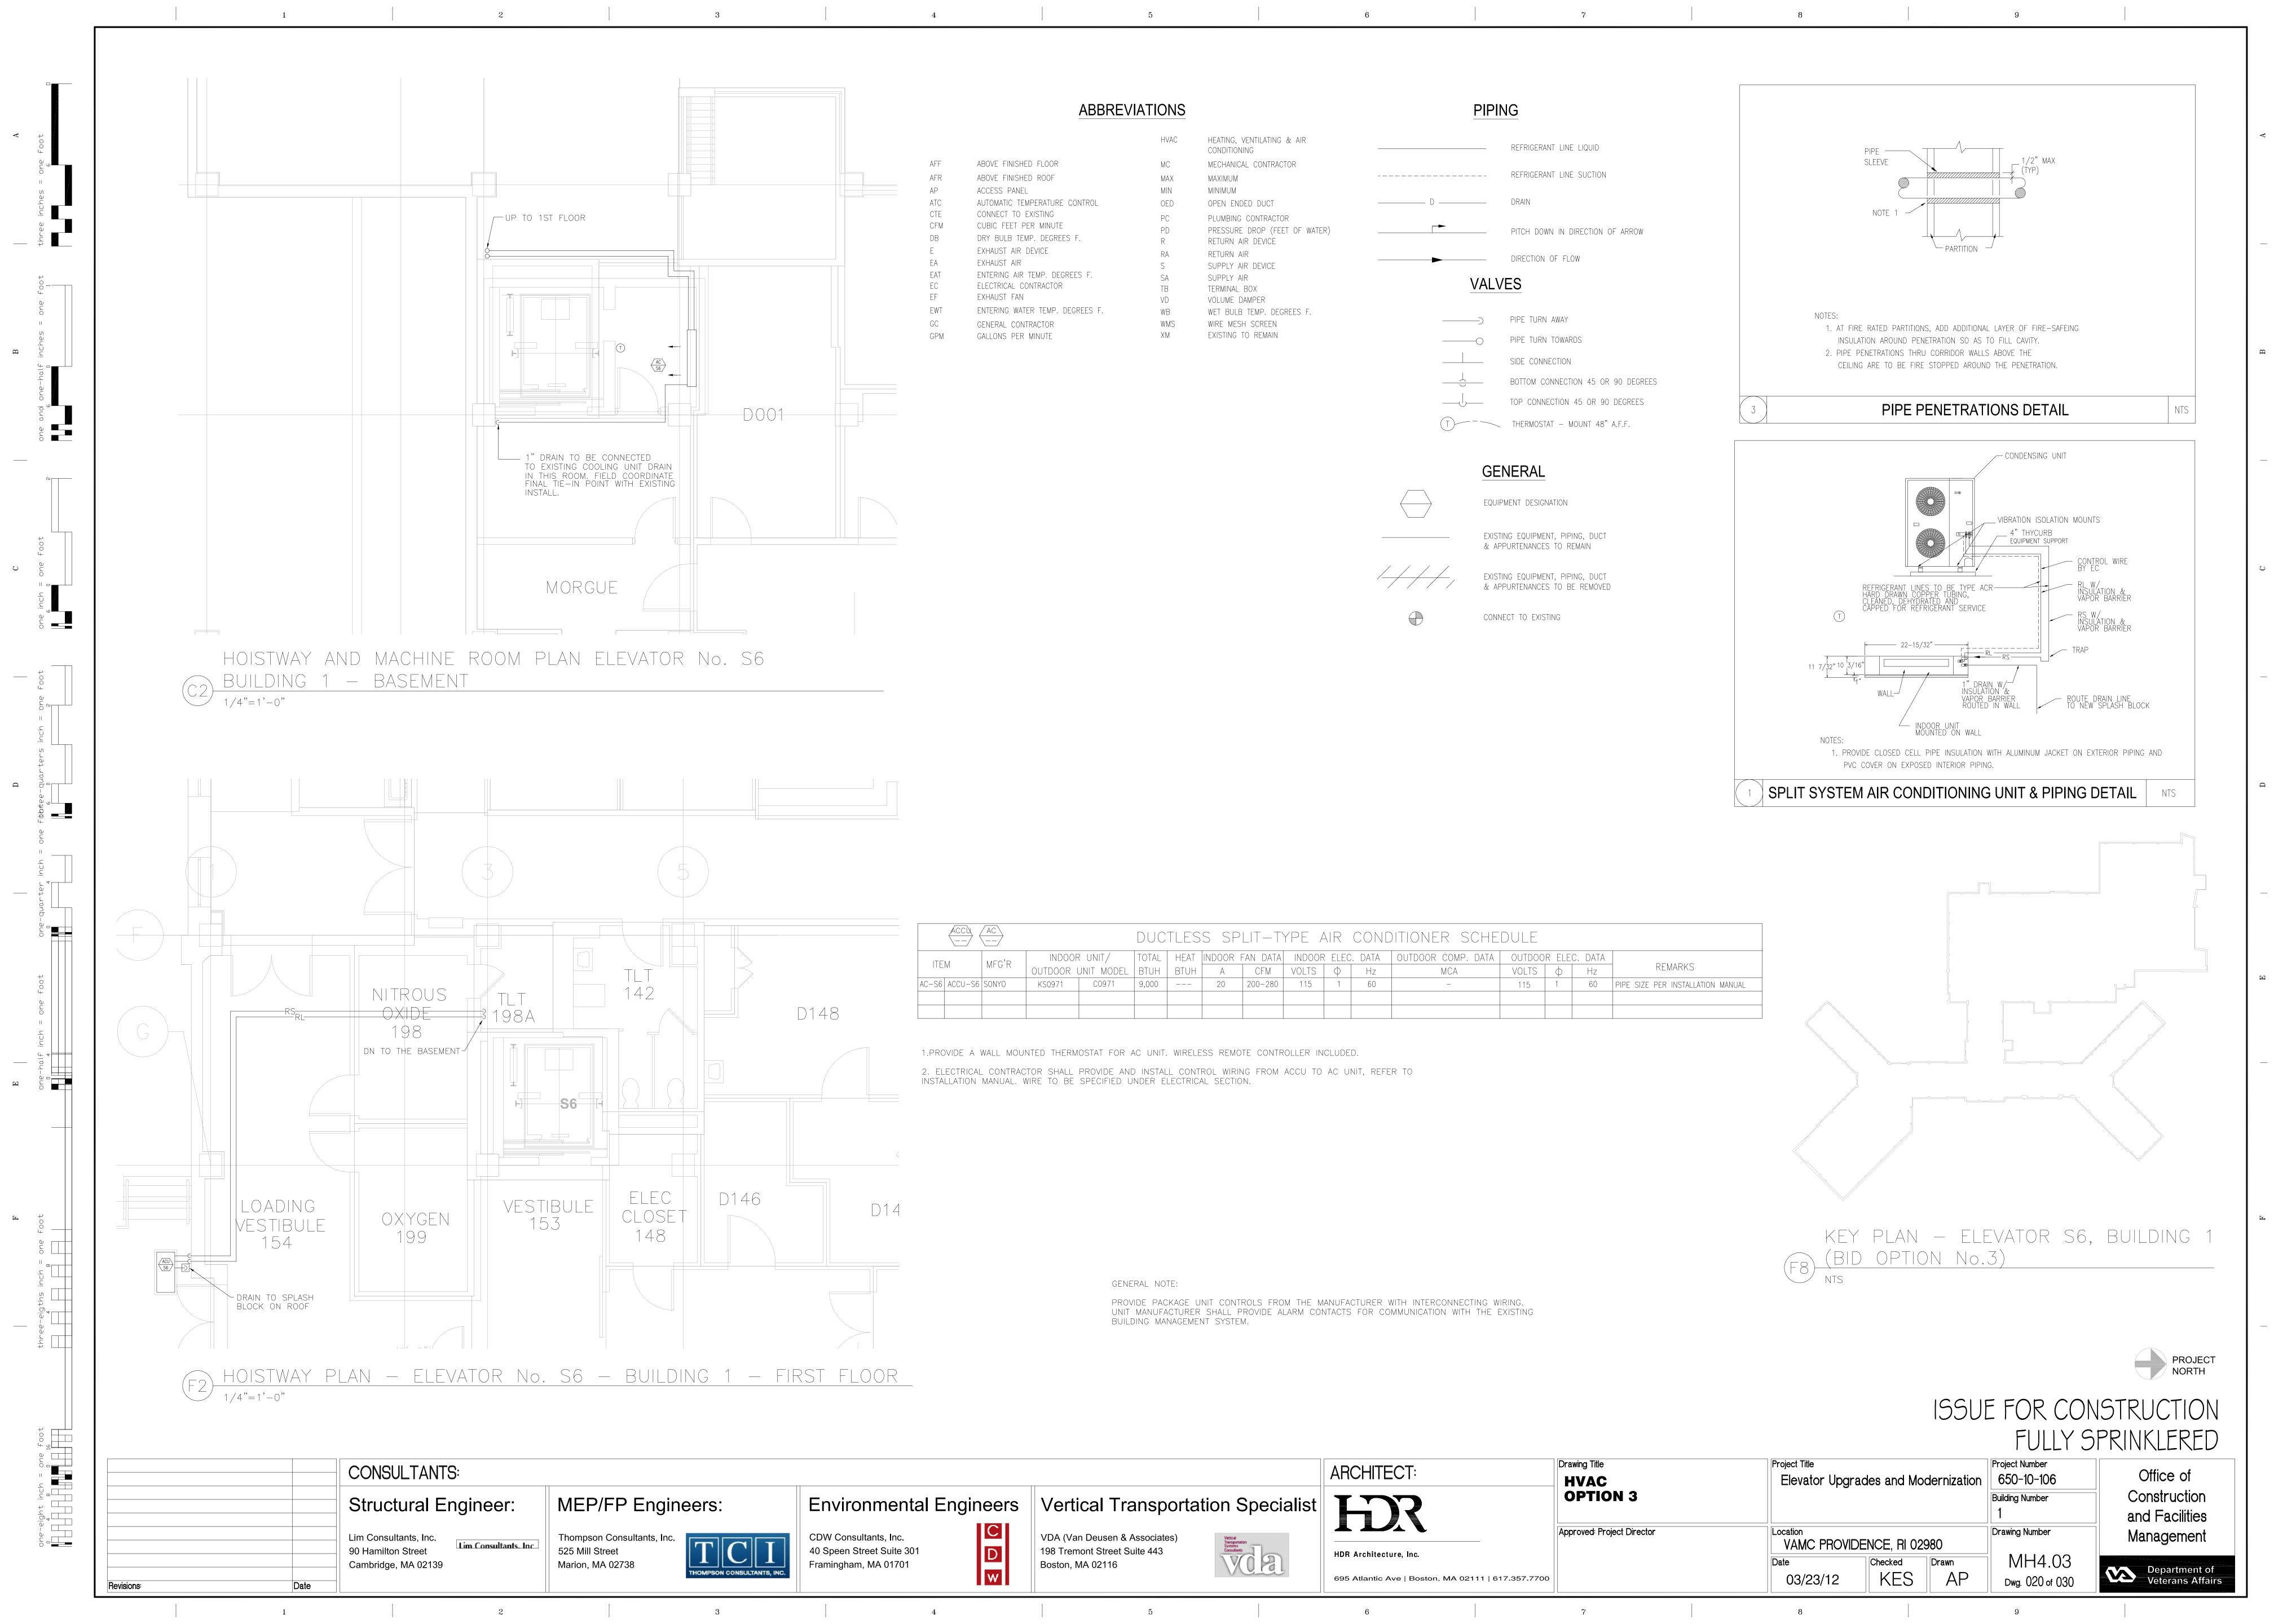


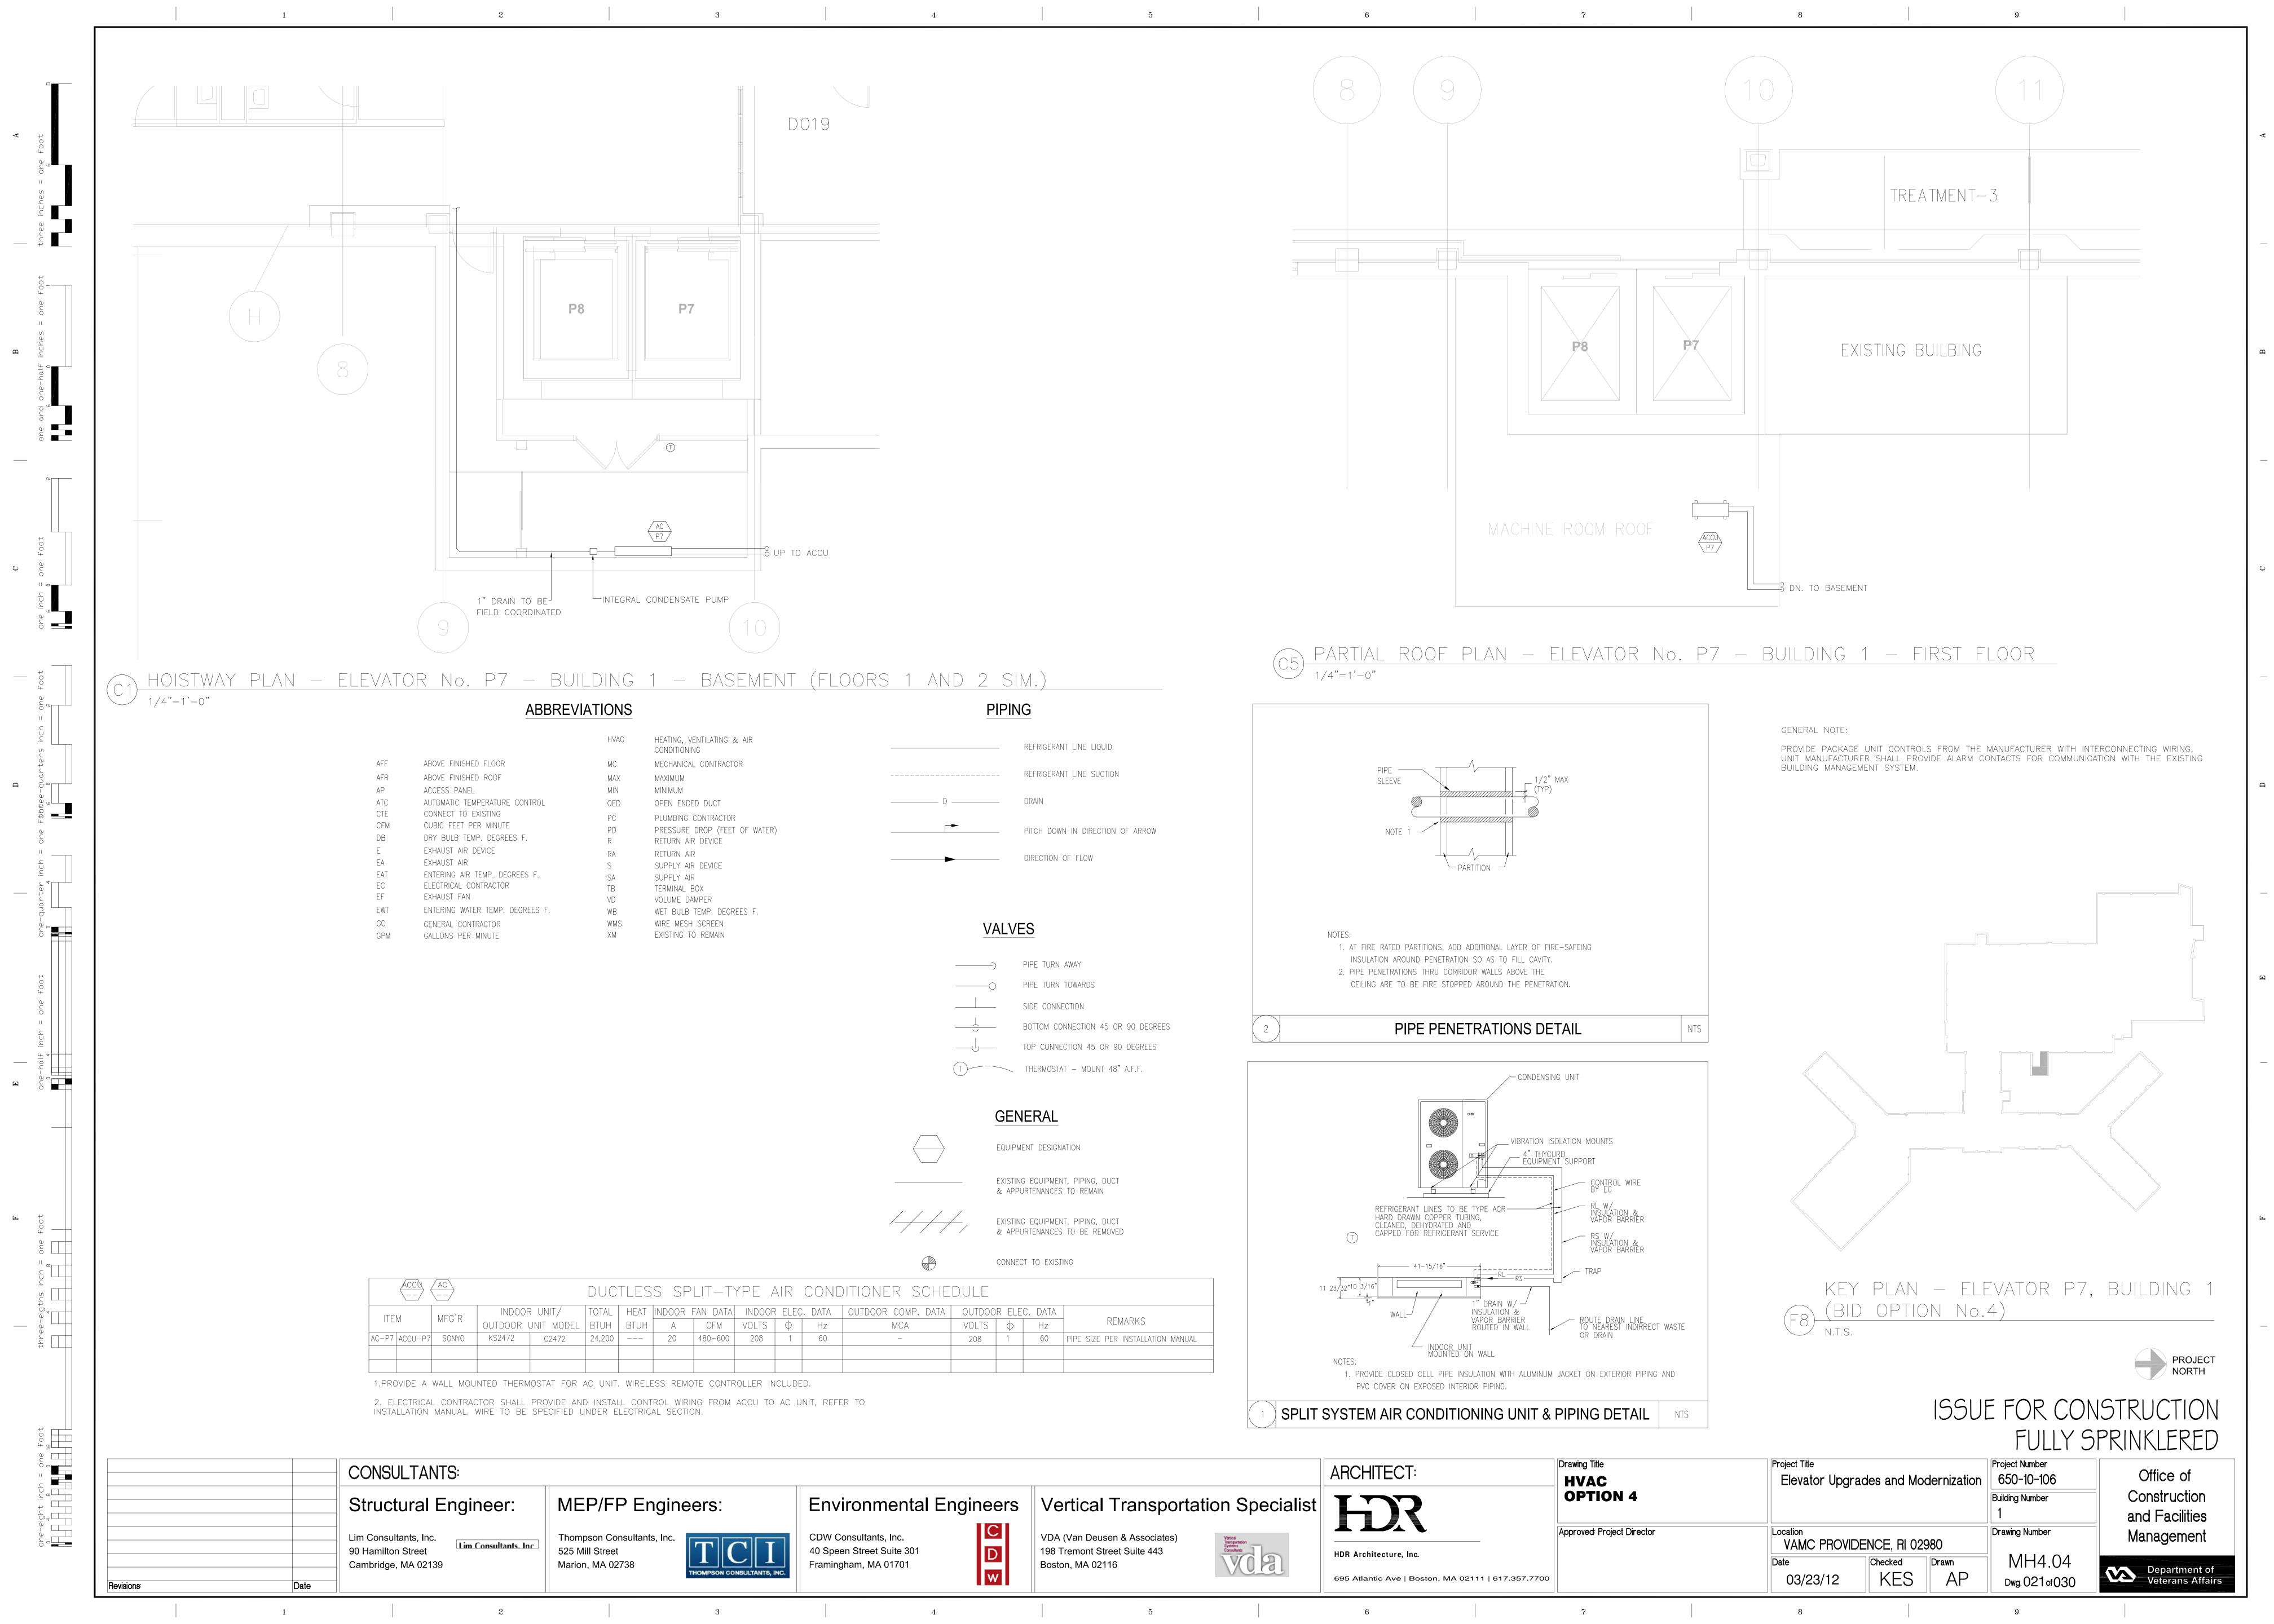


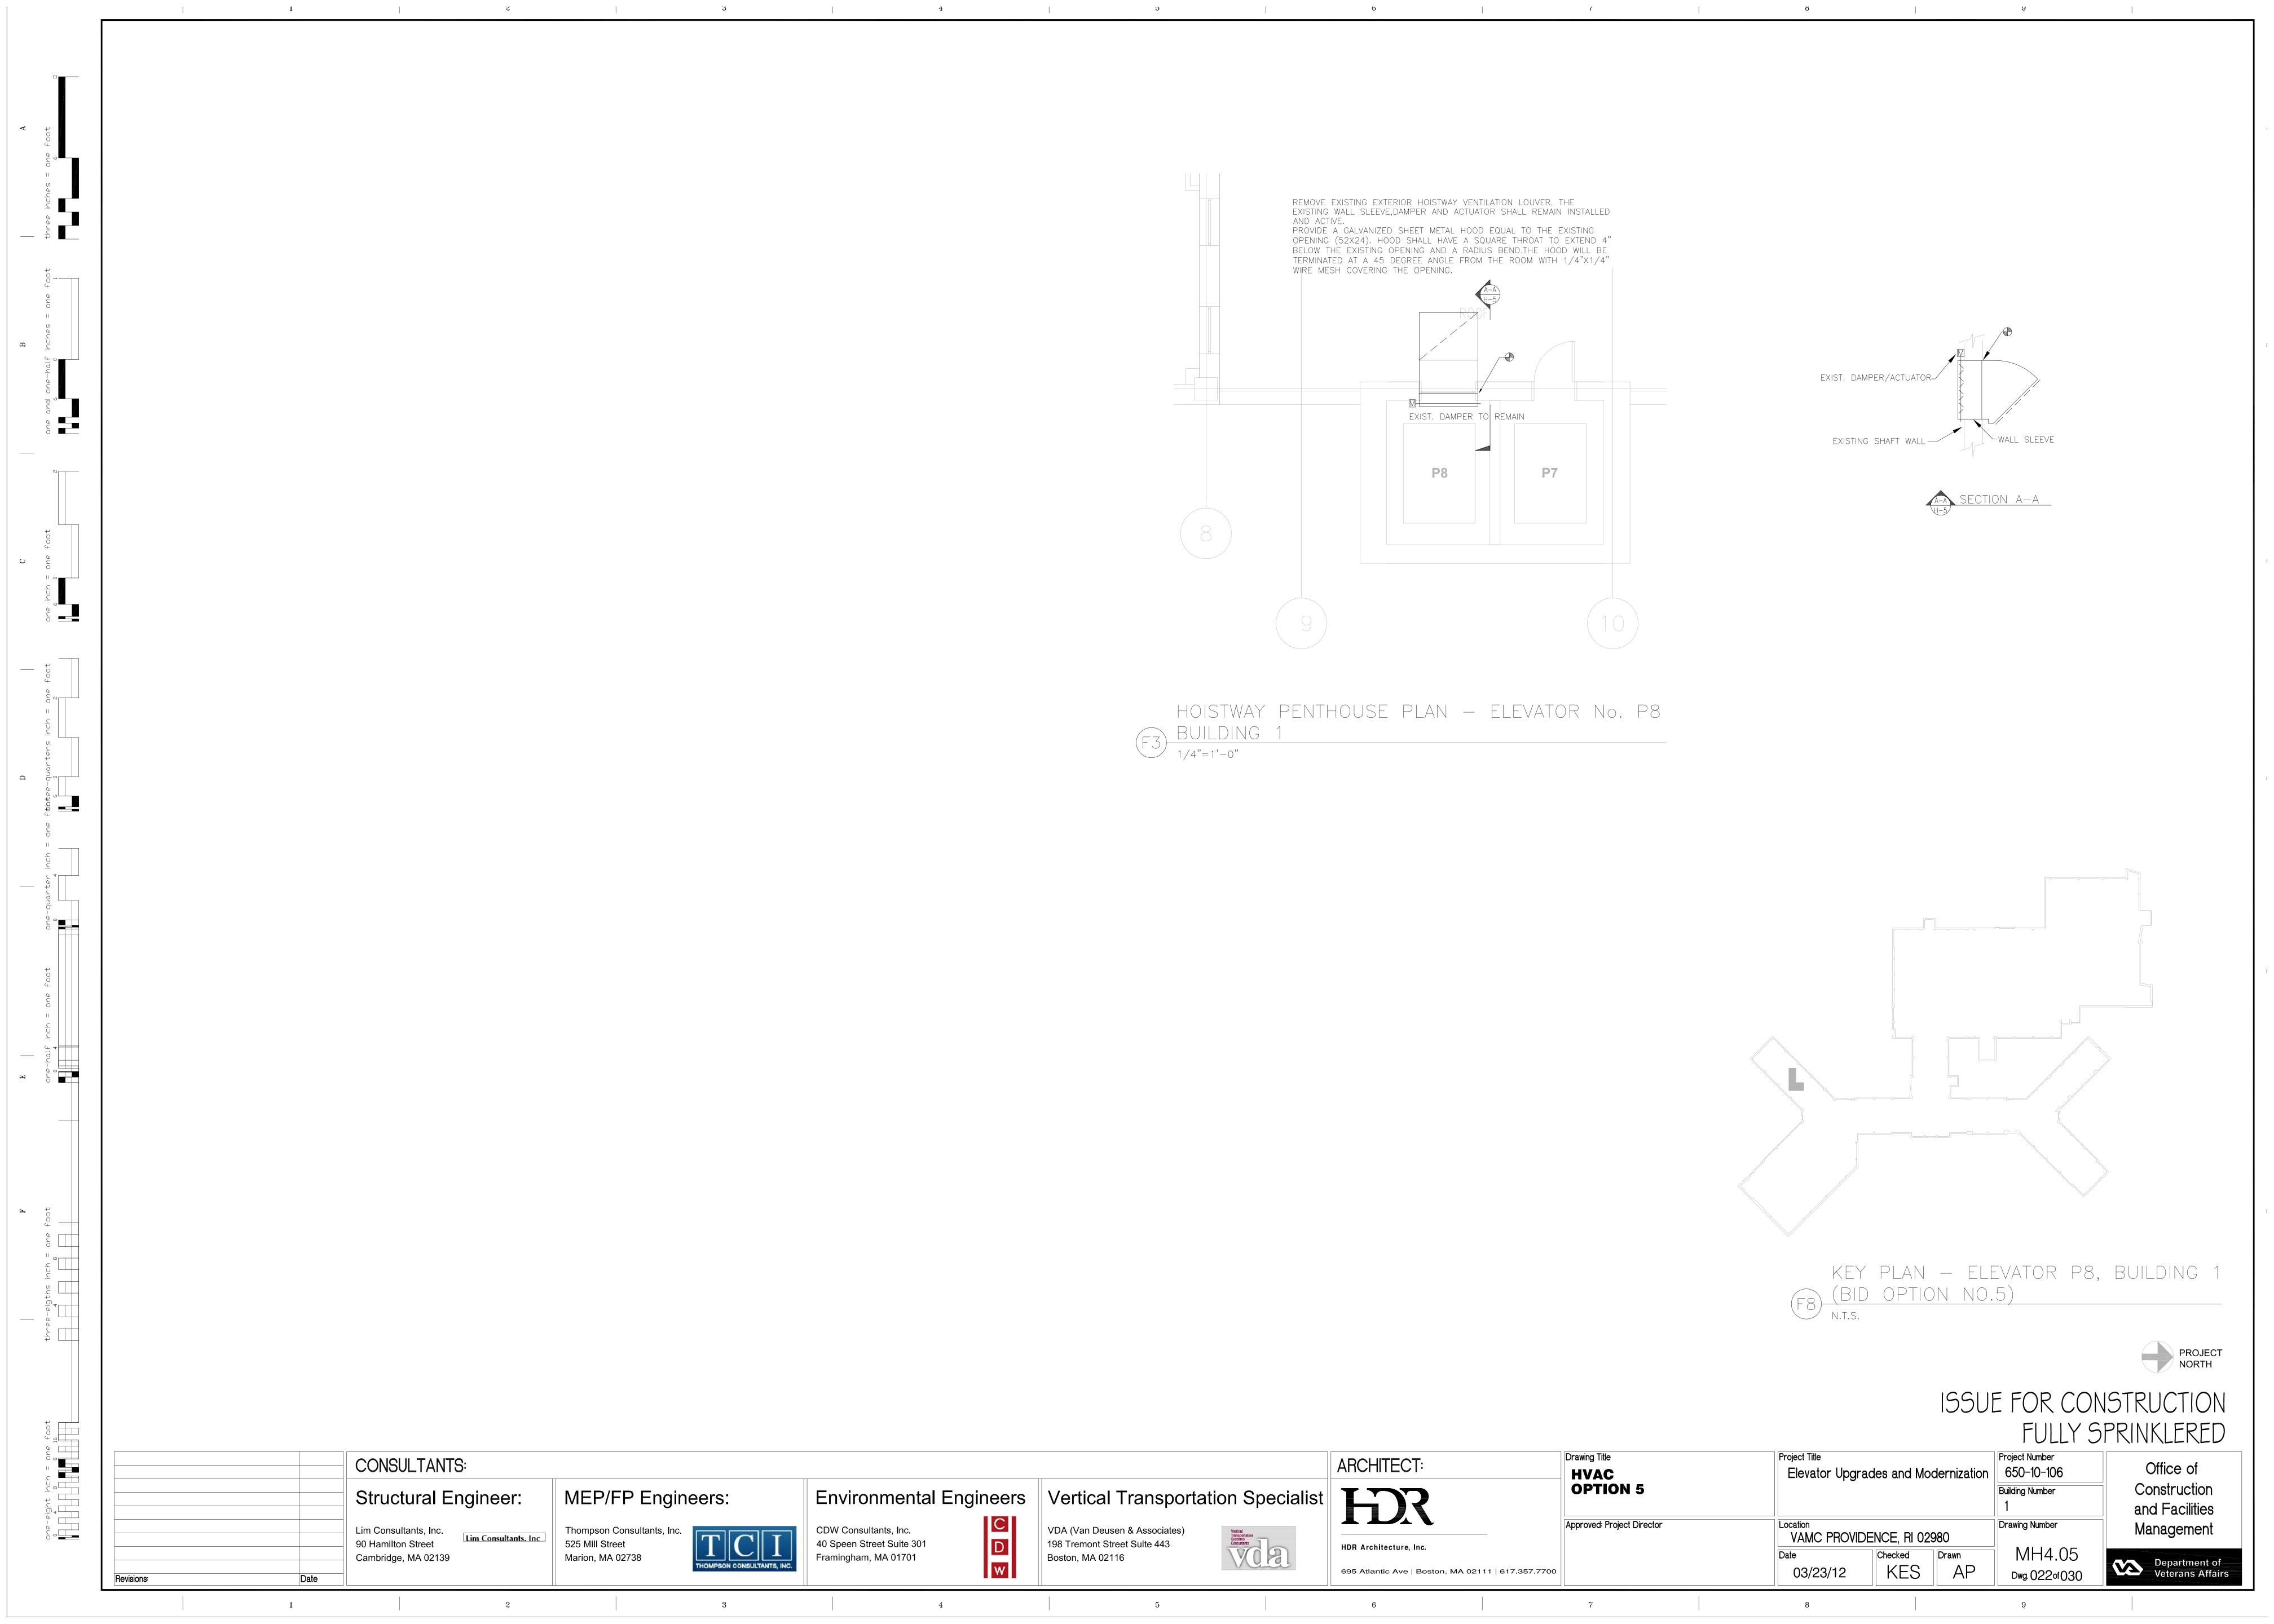


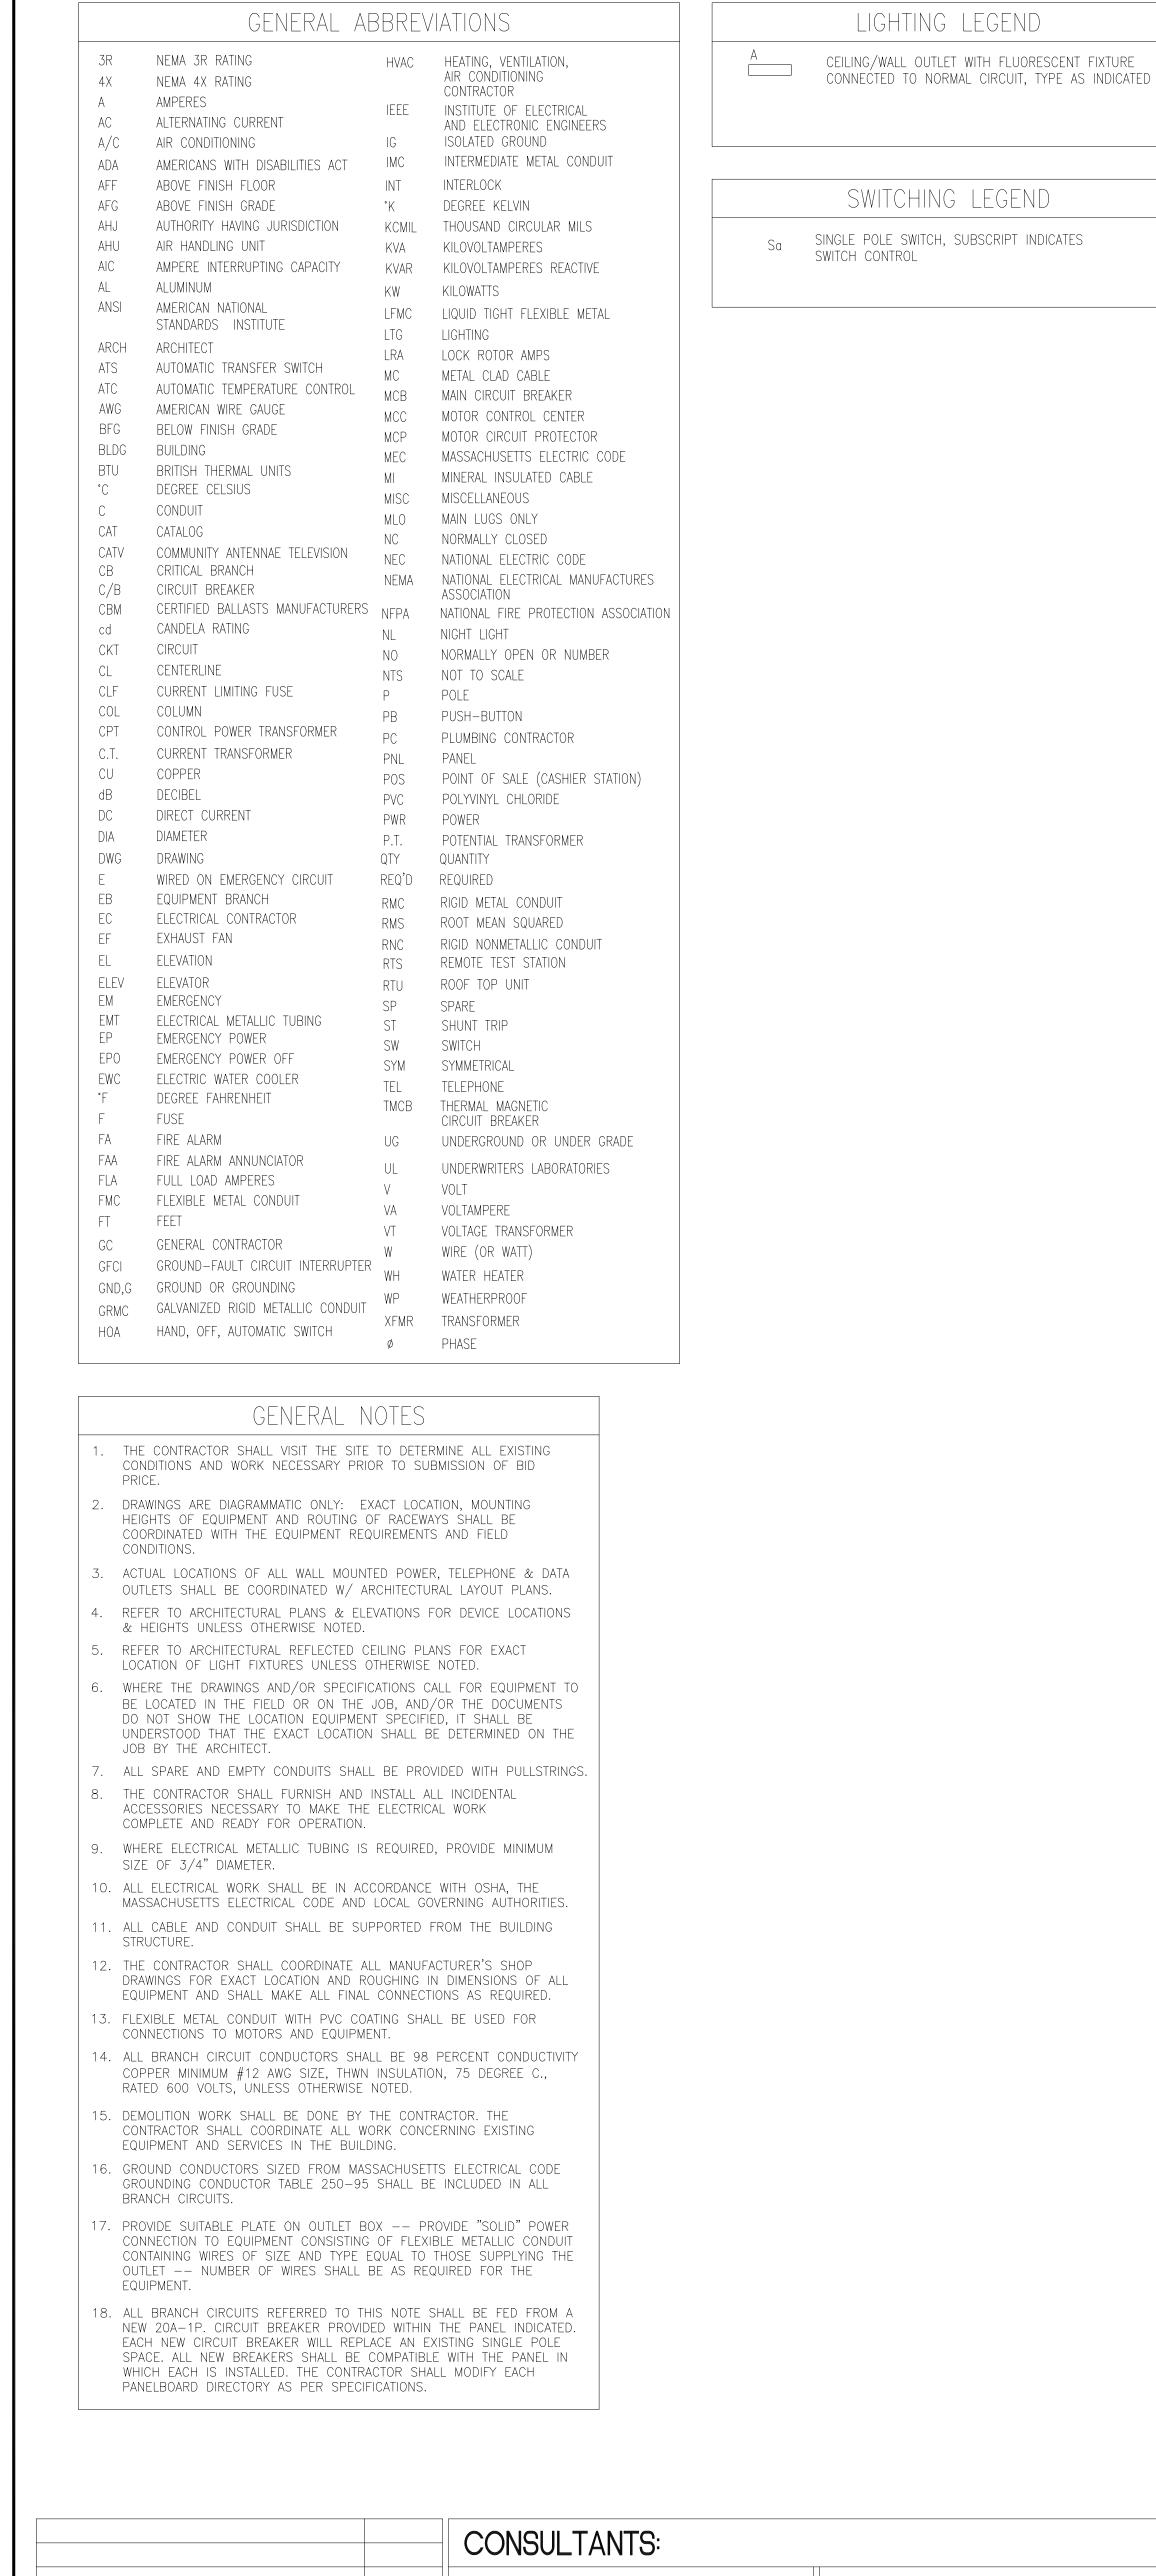


H 0

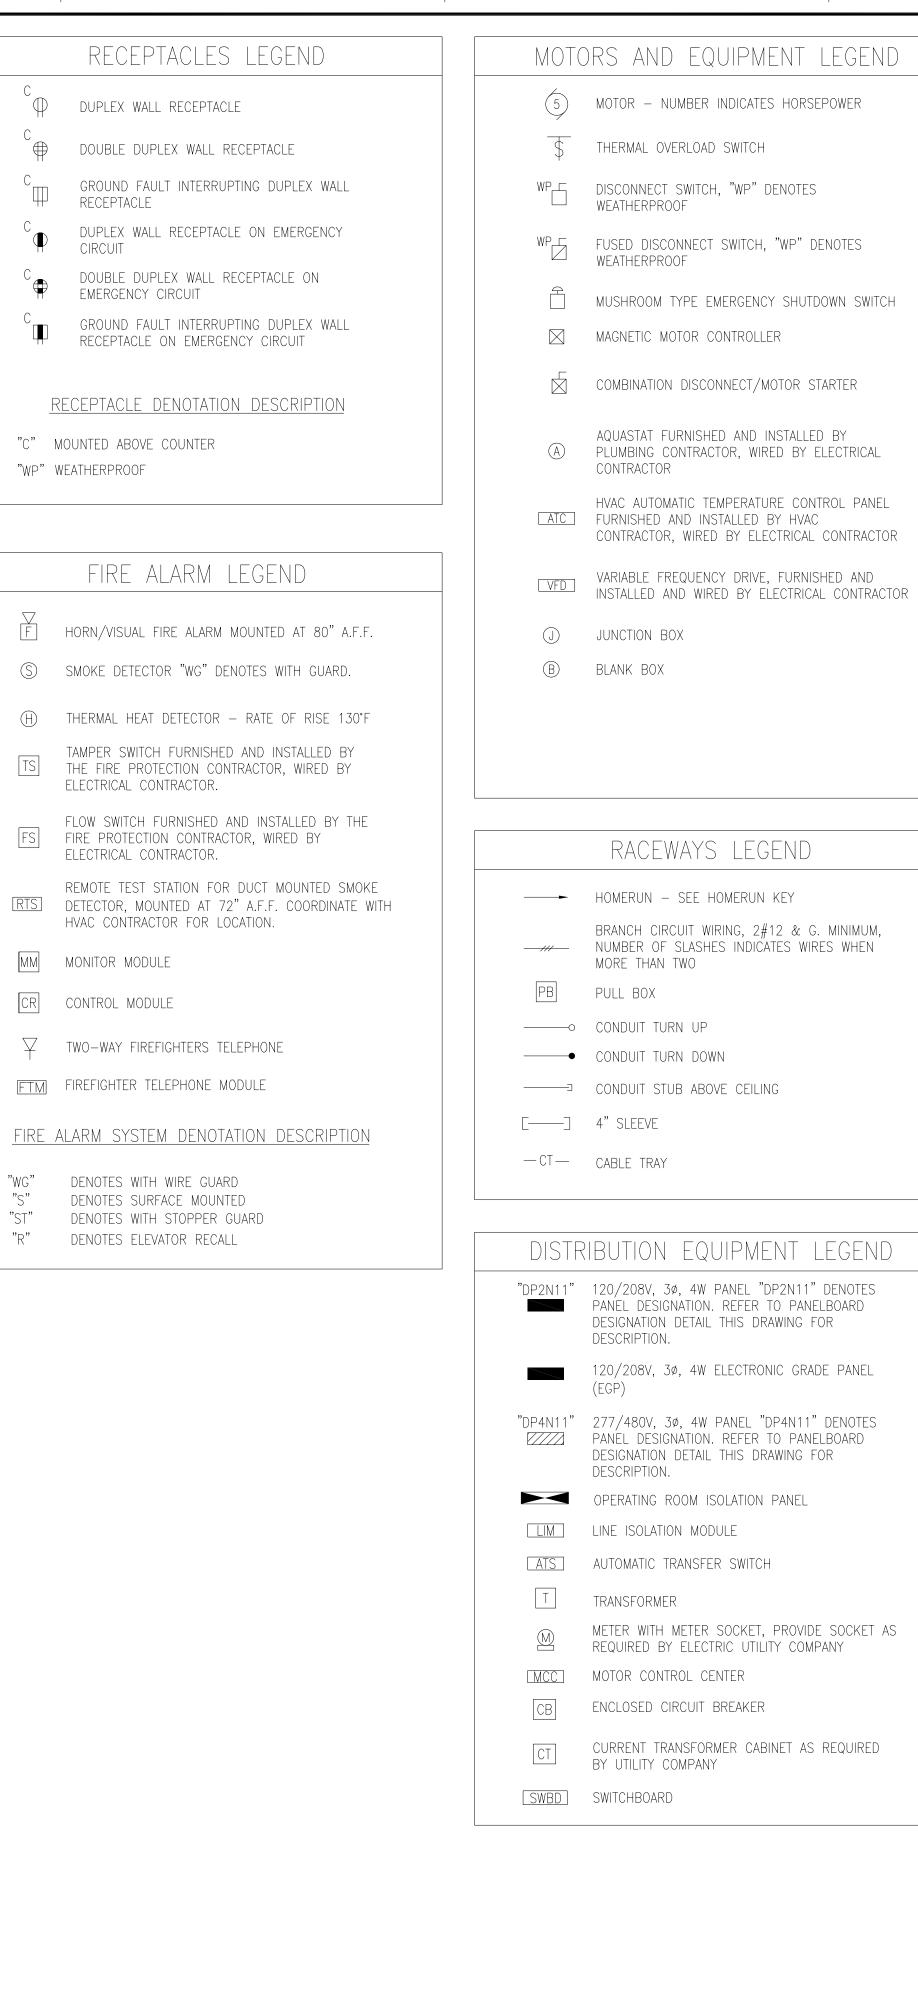

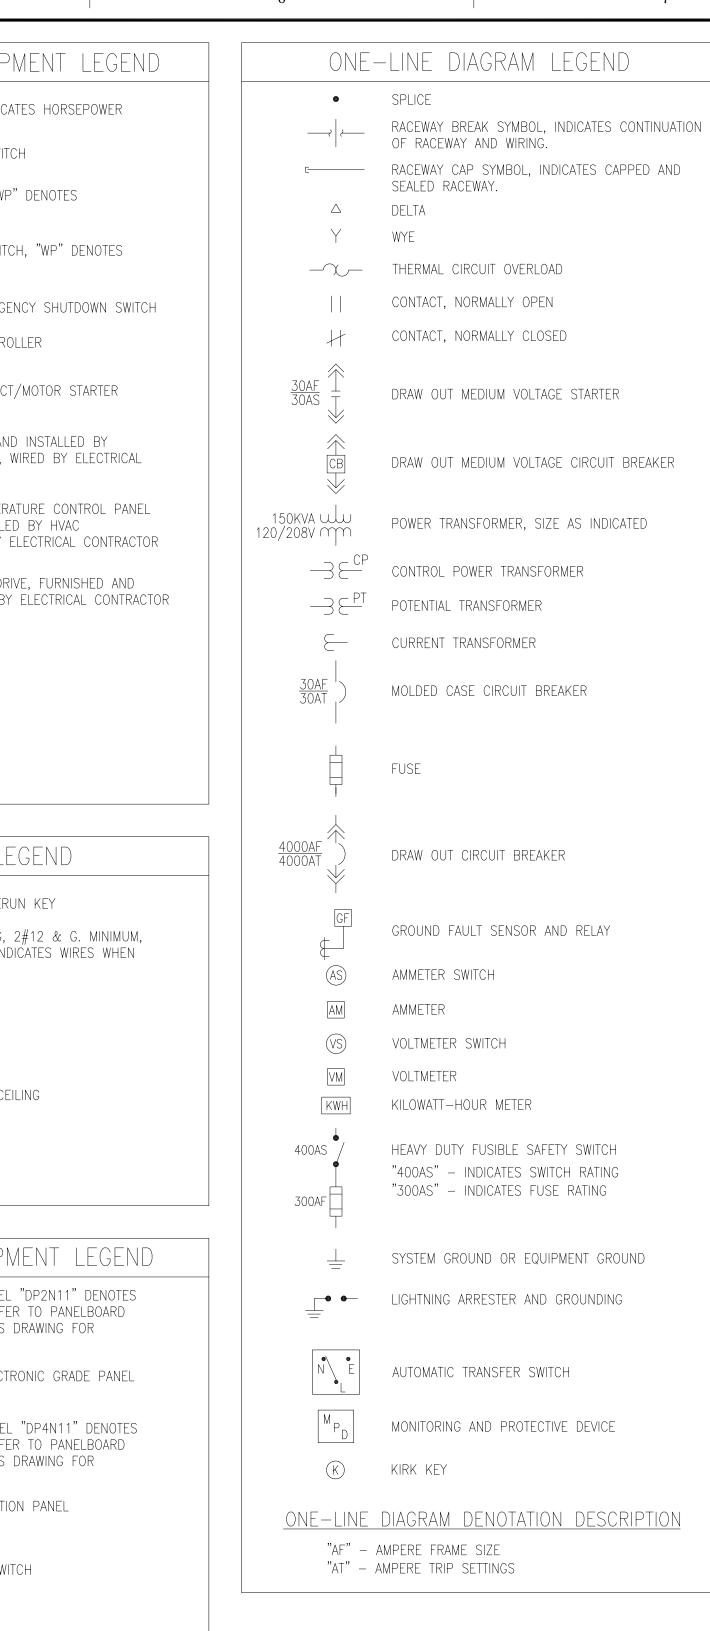

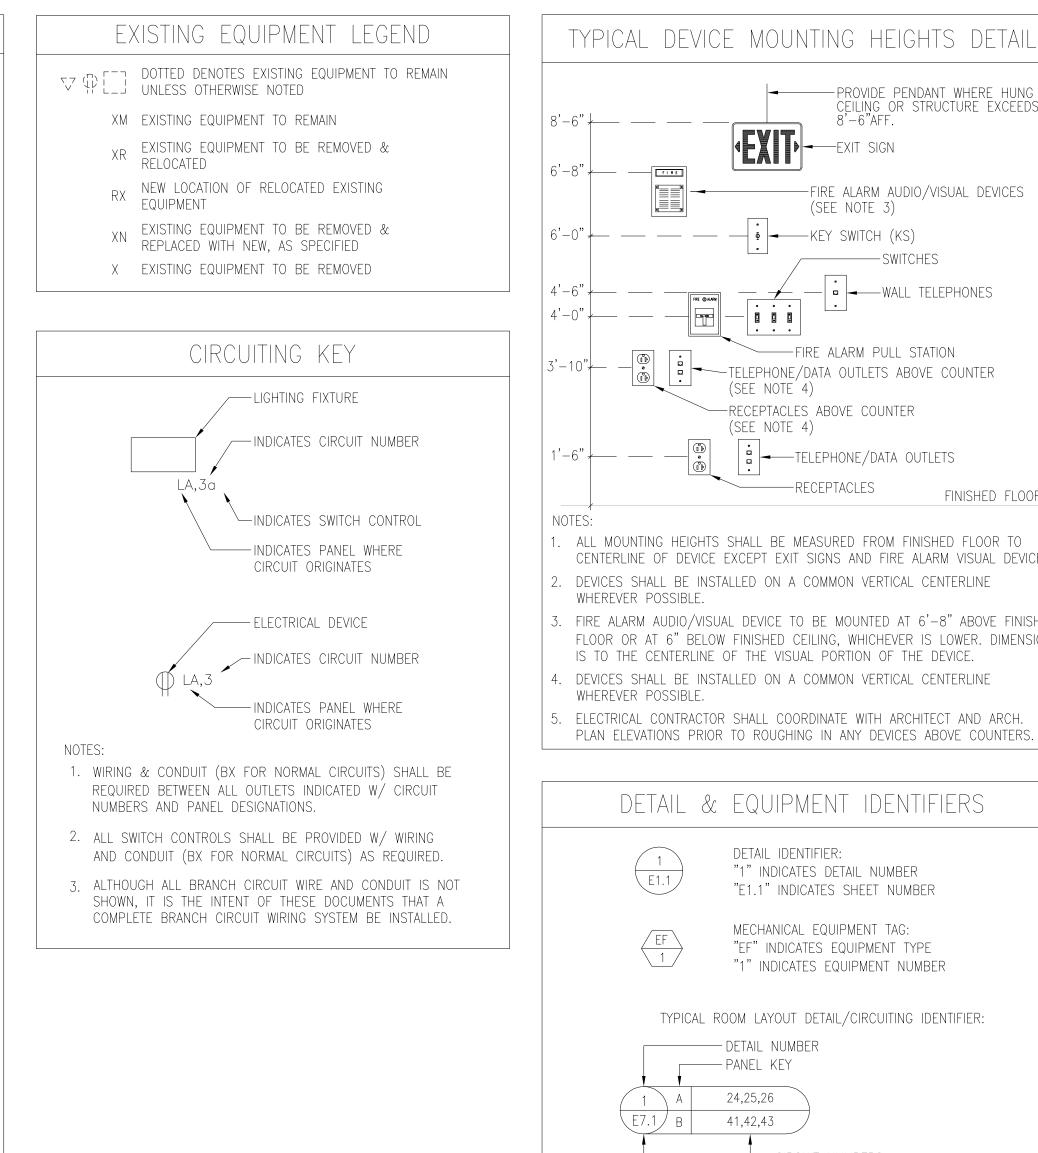

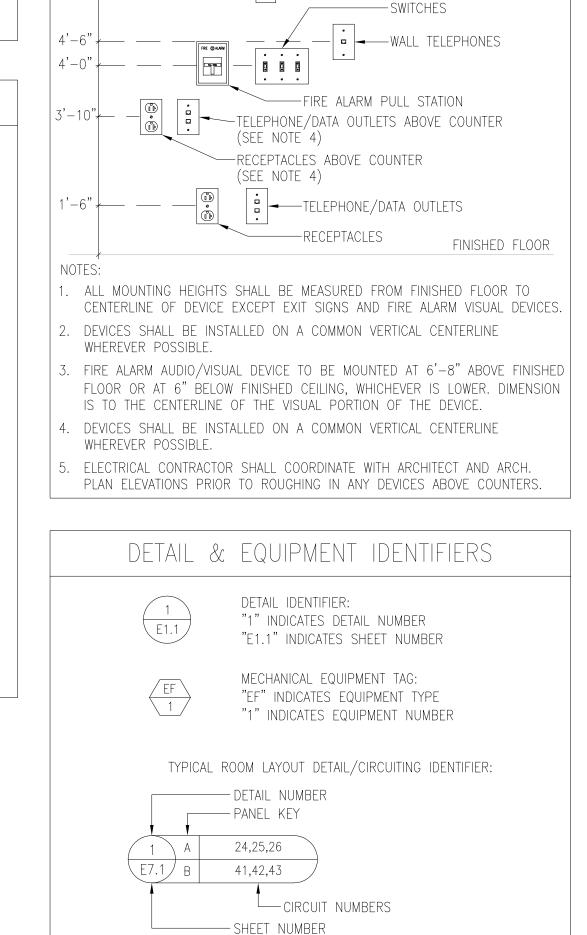


PROVIDE PENDANT WHERE HUNG

-----FIRE ALARM AUDIO/VISUAL DEVICES

EXIT SIGN

(SEE NOTE 3)

CEILING OR STRUCTURE EXCEEDS

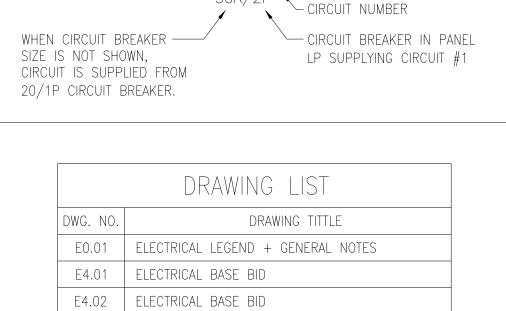

HOMERUN KEY

E4.03 | ELECTRICAL OPTION 2

E4.04 | ELECTRICAL OPTION 3

E4.05 | ELECTRICAL OPTION 4

E4.06 | ELECTRICAL OPTION 5

E4.07 | ELECTRICAL OPTION 6

PANEL DESIGNATION WHERE

CIRCUITS ORIGINATE



# ISSUE FOR CONSTRUCTION FULLY SPRINKLERED

